MOORE PUBLIC SCHOOLS RED OAK ELEMENTARY SCHOOL – SECURITY UPGRADES AND CAMPUS ENCLOSURE

Moore Public Schools - Moore, Oklahoma AGP - Moore, Oklahoma

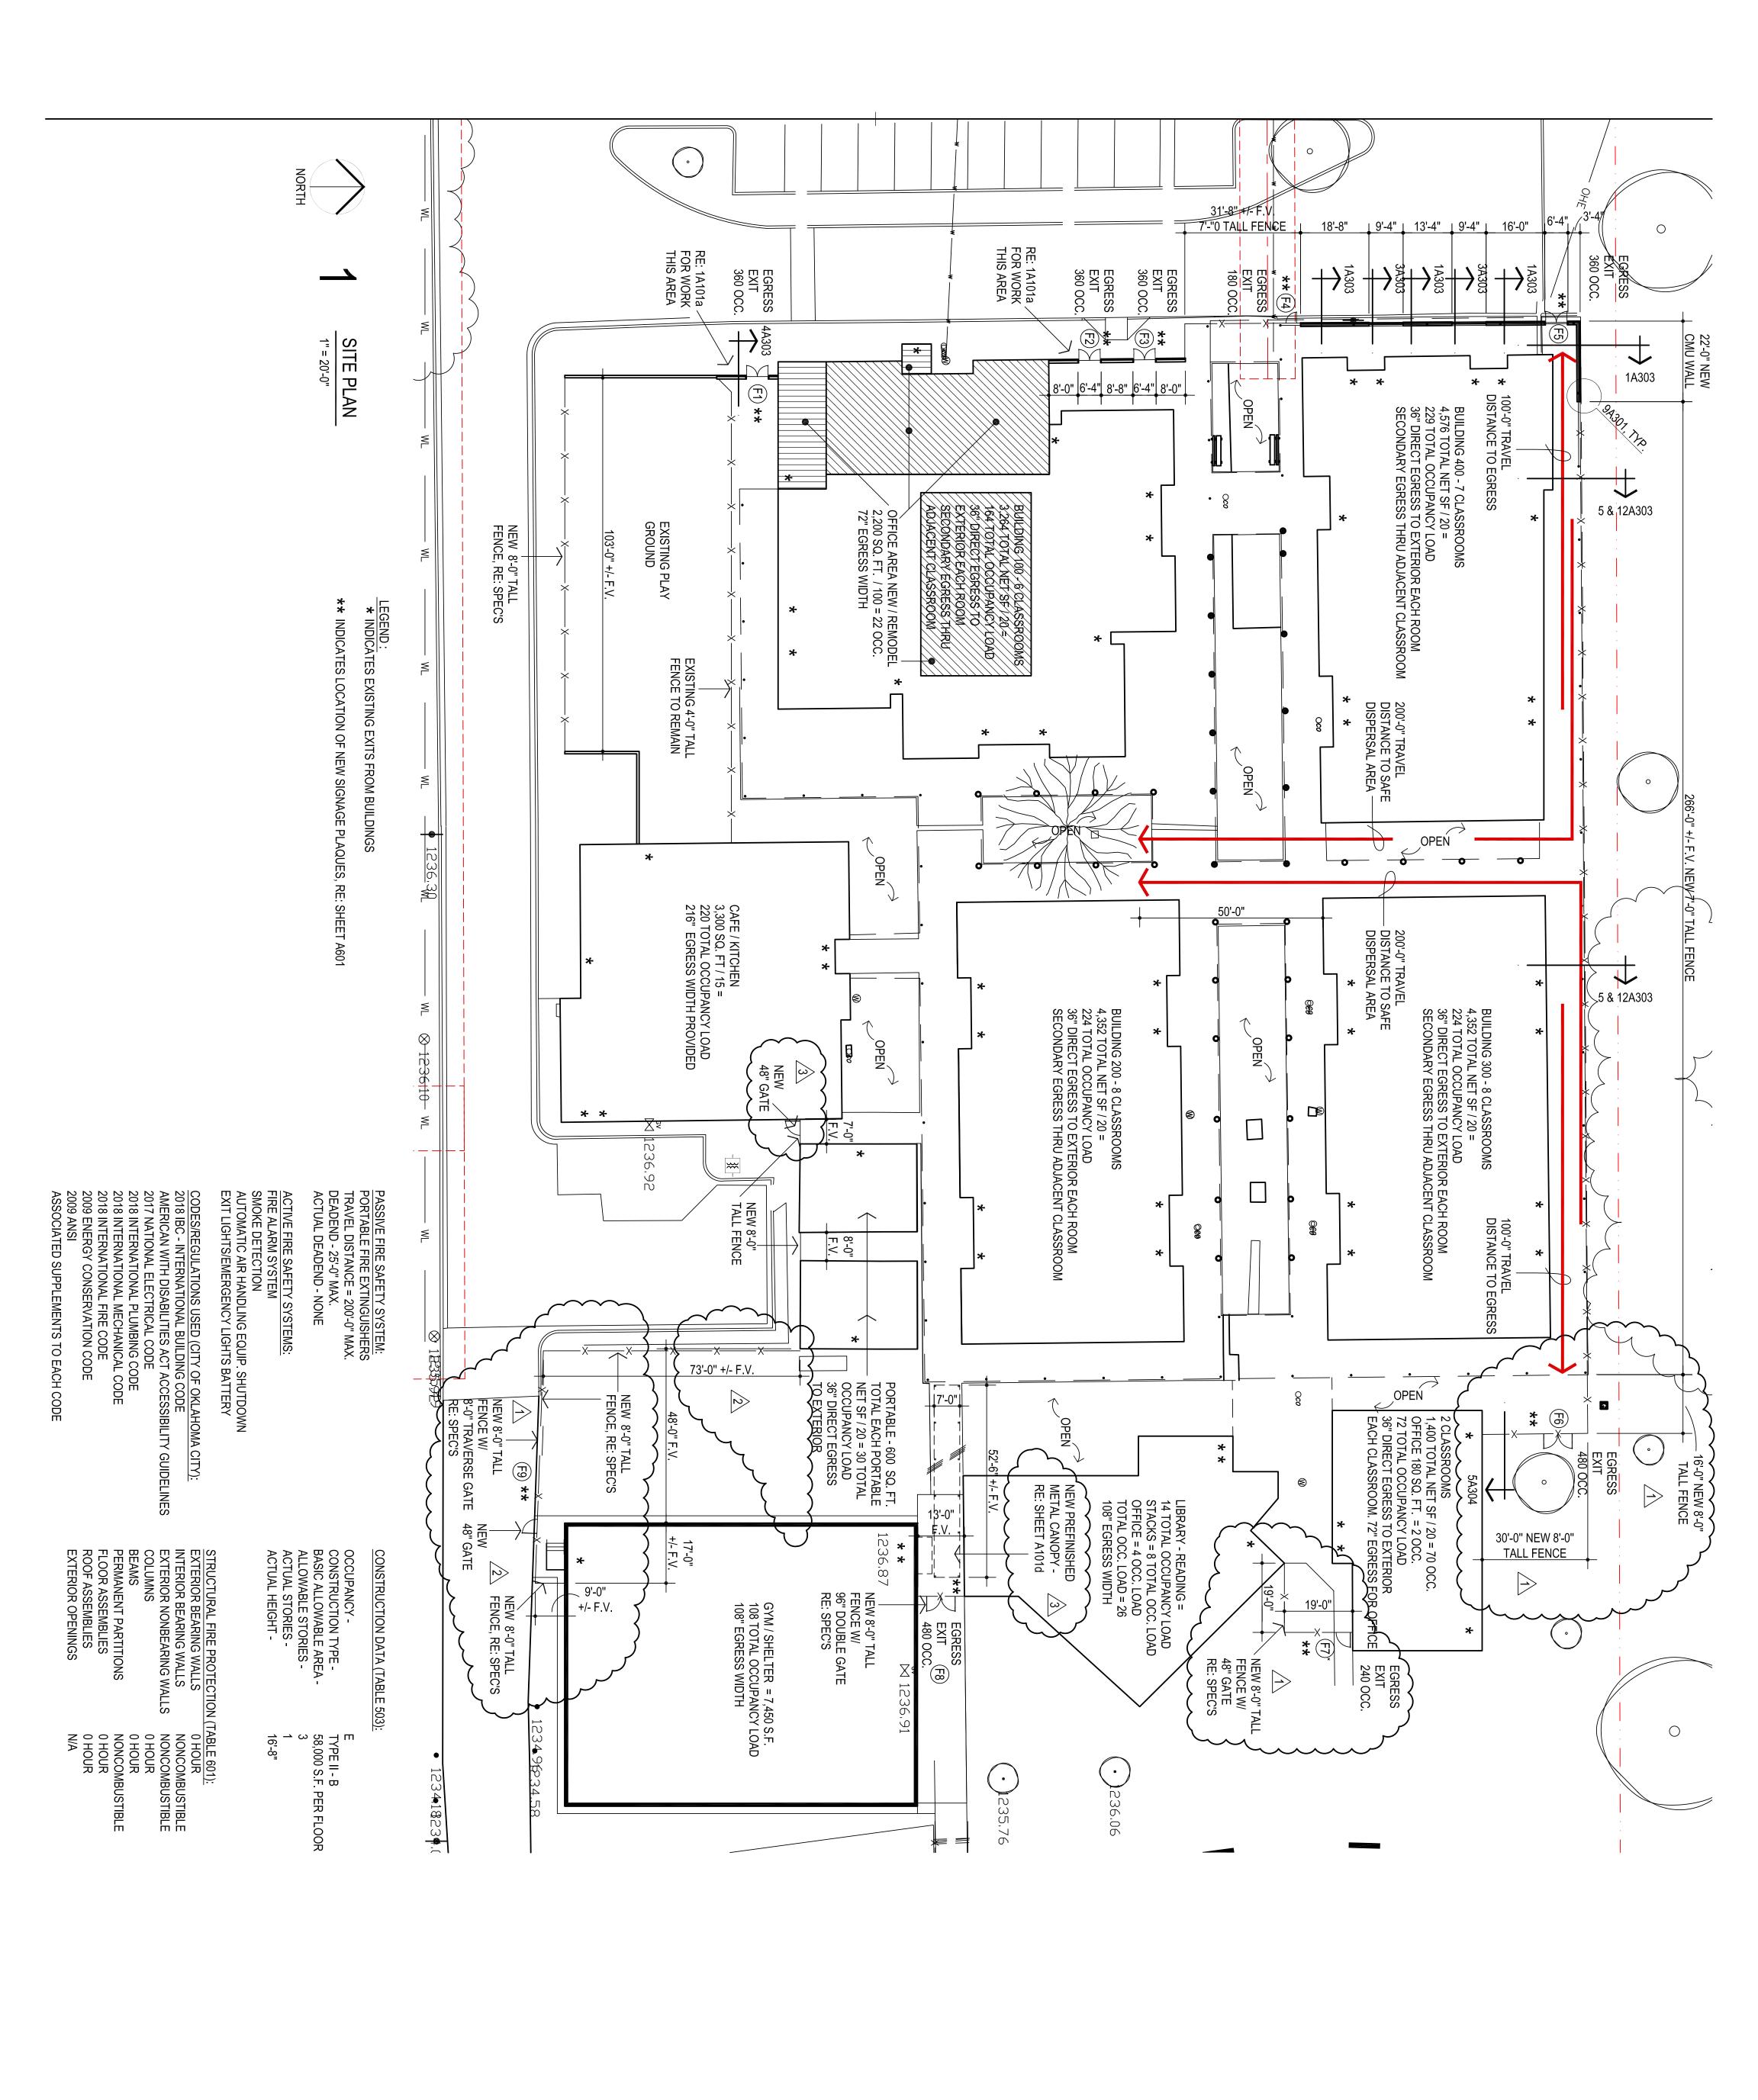
CONSTRUCTION BULLETIN NO. 10

February 24, 2025

1. AS NOTED ON ATTACHED DRAWINGS, ADD NEW 48" SINGLE LEAF EXODUS EGRESS GATE/DOOR BETWEEN EXISTING CAFETERIA AND PORTABLE CLASSROOM BUILDING. GATE, HARDWARE, FENCING, ETC. SHALL BE THE SAME AS THE ITEMS ALREADY ACQUIRED AND INSTALLED ON THIS PROJECT.

- 2. PROVIDE NEW PREFINISHED METAL CANOPY AS INDICATED ON ATTACHED DETAILS 1A101, 4 & 5A101d. REFER TO ATTACHED SPECIFICATIONS FOR CANOPY REQUIREMENTS. PROVIDE GUTTERS, DOWNSPOUTS, FLASHING, ETC. CARE IS TO BE TAKEN DURING TEMPORARY REMOVAL OF MEMORIAL BRICKS, THEIR STORAGE, AND REINSTALLATION. ALL WORK SHALL BE COORDINATED WITH ARCHITECT.
- 3. ALL EXODUS/EGRESS GATES, FENCE PANELS AT EACH SIDE OF THE OPENINGS SHALL RECEIVE METAL MESS PANELS TO PREVENT THE POSSIBILITY OF REACHING-AROUND AND TRIPPING THE PANIC DEVICE TO GAIN ENTRY TO THE CAMPUS. MESH SHALL BE BLACK AND AS PER PREVIOUS CONVERSATIONS BETWEEN THE CM, THE ARCHITECT, AND THE FENCE SUPPLIER/MANUFACTURER. PLEASE VERIFY MATERIAL, INSTALLATION, ETC. WITH ARCHITECT PRIOR TO STARTING WORK. INCLUDING NEW GATE ADDED ABOVE, THERE SHOULD BE FOUR OPENINGS AFFECTED -CM TO FIELD VERIFY.
- 4. REFER TO ATTACHED DRAWINGS, ETC. CONCERNING NEW ACCESS CONTROL PANEL, PLYWOOD PANEL LOCATION, POST MOUNTED CARD READERS, ETC.

END OF CONSTRUCTION BULLETIN NO. 10



the Abla Griffin

Partnership L.L.C.

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KFC ENGINEERING

PLUMBING / MECHANICAL / ELECTRICAL SALAS O'BRIEN

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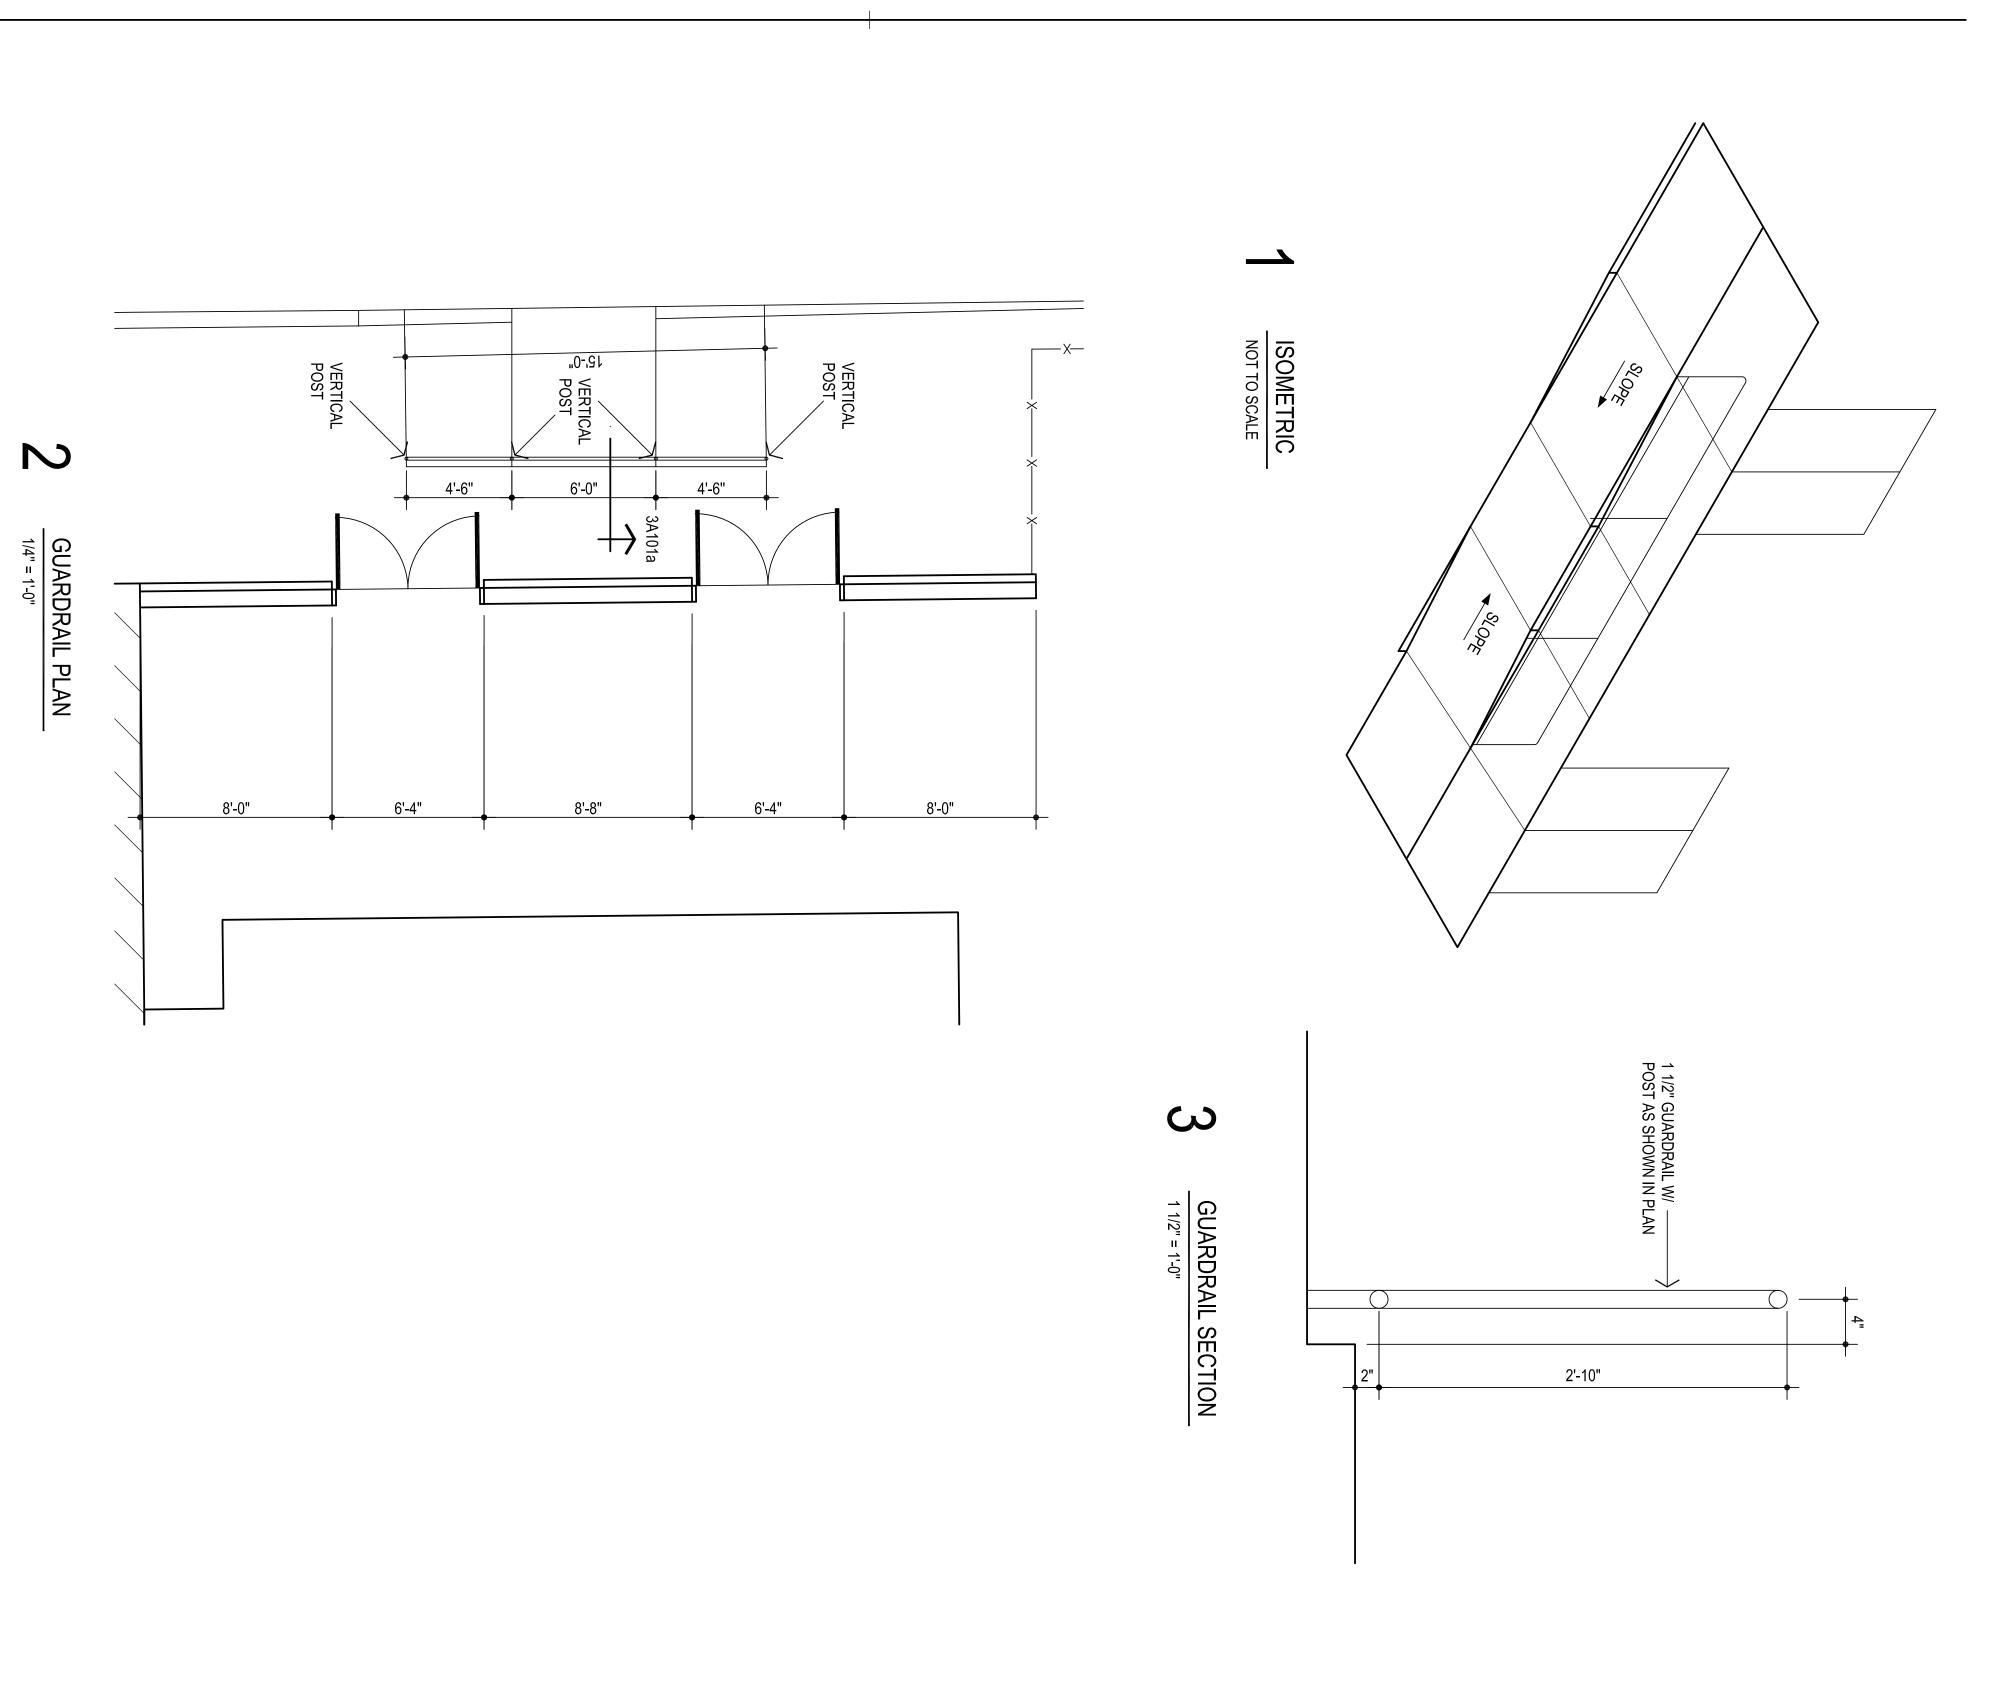
MAY 2024 date MA checked by 2> ω . CB-10 CB-3 ADDENDUM #3

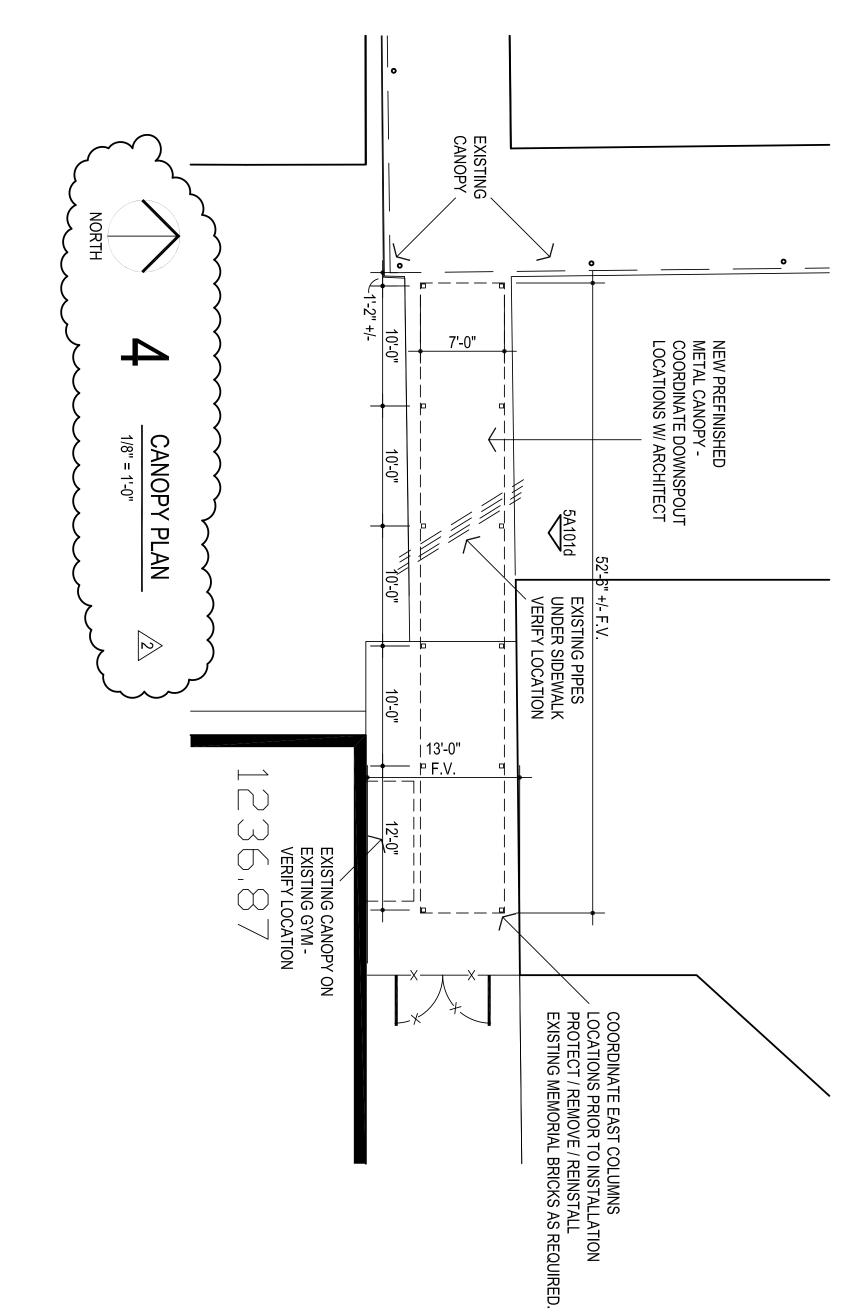
MOORE PUBLIC SCHOOLS BOARD OF EDUCATION MOORE, OKLAHOMA

MOORE Public Schools

RED OAK ELEMENTARY SCHOOL SECURITY UPGRADES

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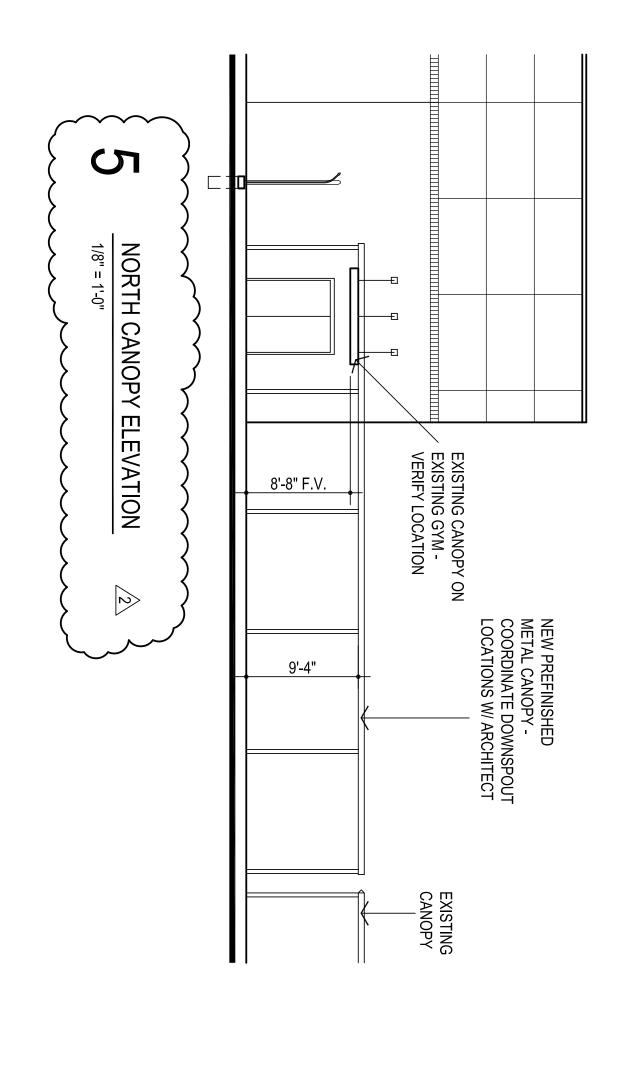
SALAS O'BRIEN

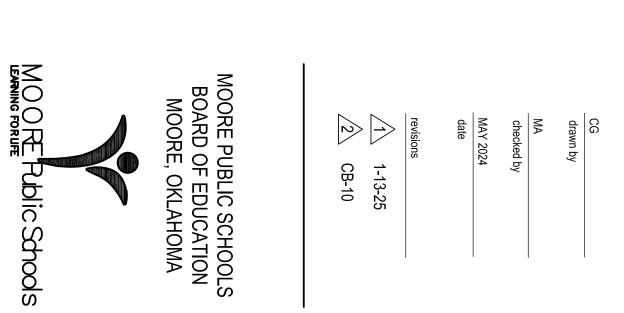
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ENTIRE SHEET RED OAK ELEMENTARY SCHOOL SECURITY UPGRADES

A101d

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DIVISION 10 - SPECIALTIES

SECTION 10530 - POST SUPPORTED WALKWAY CANOPIES

Part 1 - General

1.1 Description of Work

- 1. Work in this section includes furnishing and installation of extruded aluminum walkway canopies or extruded aluminum wall-supported canopies as manufactured by Mapes Industries Inc. or approved equal.
- 2. Related Items and Considerations
 - 1. Flashing of various designs may be required. Generic flashing supplied by Mapes. Specialty flashing to be supplied by installer.
 - 2. Determine wall construction, make-up and thickness.
 - 3. Ensure adequate wall condition to carry canopy loads where required.
 - 4. Consider water drainage away from canopy where necessary.
 - 5. Any necessary removal or relocation of existing structures, obstructions or materials.

1.2 Quality Assurance

1. Products meeting these specifications established standard of quality required as manufactured by Mapes Industries, Inc. Lincoln, Nebraska 1-888-273-1132.

1.3 Field Measurement

- 1. Confirm dimensions prior to preparation of shop drawings when possible.
- 2. If requested, supply manufacturer's standard literature and specifications for canopies.
- 3. Submit shop drawings showing structural component locations/positions, material dimensions and details of construction and assembly.

1.4 Performance Requirements

- 1. Canopy must conform to local building codes.
- 2. PE Stamped calculations are not required.

1.5 Deliver, Storage, Handling

- 1. Deliver and store all canopy components in protected areas.
- 1.6 Products of certain manufacturers are specified herein to simplify descriptions of design, construction, and/or materials only. Proprietary names are not intended to imply that products of named manufacturer are required to the exclusion of equivalent products of other manufacturers.

DIVISION 10 - SPECIALTIES

SECTION 10530 - POST SUPPORTED WALKWAY CANOPIES

Part 2 - Products

2.1 Manufacturer

1. Mapes Canopies

Lincoln, Nebraska

Phone: 1-888-273-1132.

Fax: 1-877-455-6572.

2.2 Materials

- 1. Decking shall consist of a 2 3/4" Extruded .078" Decking.
- 2. Beams shall be 4"x7".
- 3. Posts shall be 4"x4".
- 4. Fascia shall be standard extruded 8" J style.

2.3 Finishes

1. Finish type shall be 2-Coat Kynar Finish. Color to be selected by Architect from manufacturer's standard colors.

2.4 Fabrication

- 1. Support columns and gutter beams shall be designed such that the columns will be notched to create a "saddle" that will receive and secure the gutter beams.
- 2. Post and beams shall be mechanically assembled utilizing 3/16" fasteners with a minimum shear stress of 350 lb. Prewelded or factory-welded connections are not acceptable.
- 3. Decking shall be designed with interlocking extruded aluminum members with mechanical fasteners field applied to provide structural integrity for the completed assembly.
- 4. Concealed drainage. Water shall drain from covered surfaces into intermediate trough and be directed to Standard Post Drain.

Part 3 - Execution

3.1 Inspection

- 1. Confirm that surrounding area is ready for the canopy installation.
- 2. Installer shall confirm dimensions and elevations to be as shown on drawings provided by Mapes Industries.
- 3. Erection shall be performed by an approved installer and scheduled after all concrete, masonry and roofing in the area is completed

3.2 Installation

1. Installation shall be in strict accordance with manufacturer's shop drawings. Particular attention should

DIVISION 10 - SPECIALTIES

SECTION 10530 - POST SUPPORTED WALKWAY CANOPIES

be given to protecting the finish during handling and erection.

3.3 After installation, entire system shall be left in a clean condition.

End of Section



Construction Bulletin # 10

Client: Abla Griffin Partnership

Project Name: Red Oak Campus Renovation

Project Number: 2024-02321-00

February 20, 2025

Requested by: X Owner
Contractor:
Salas O'Brien:

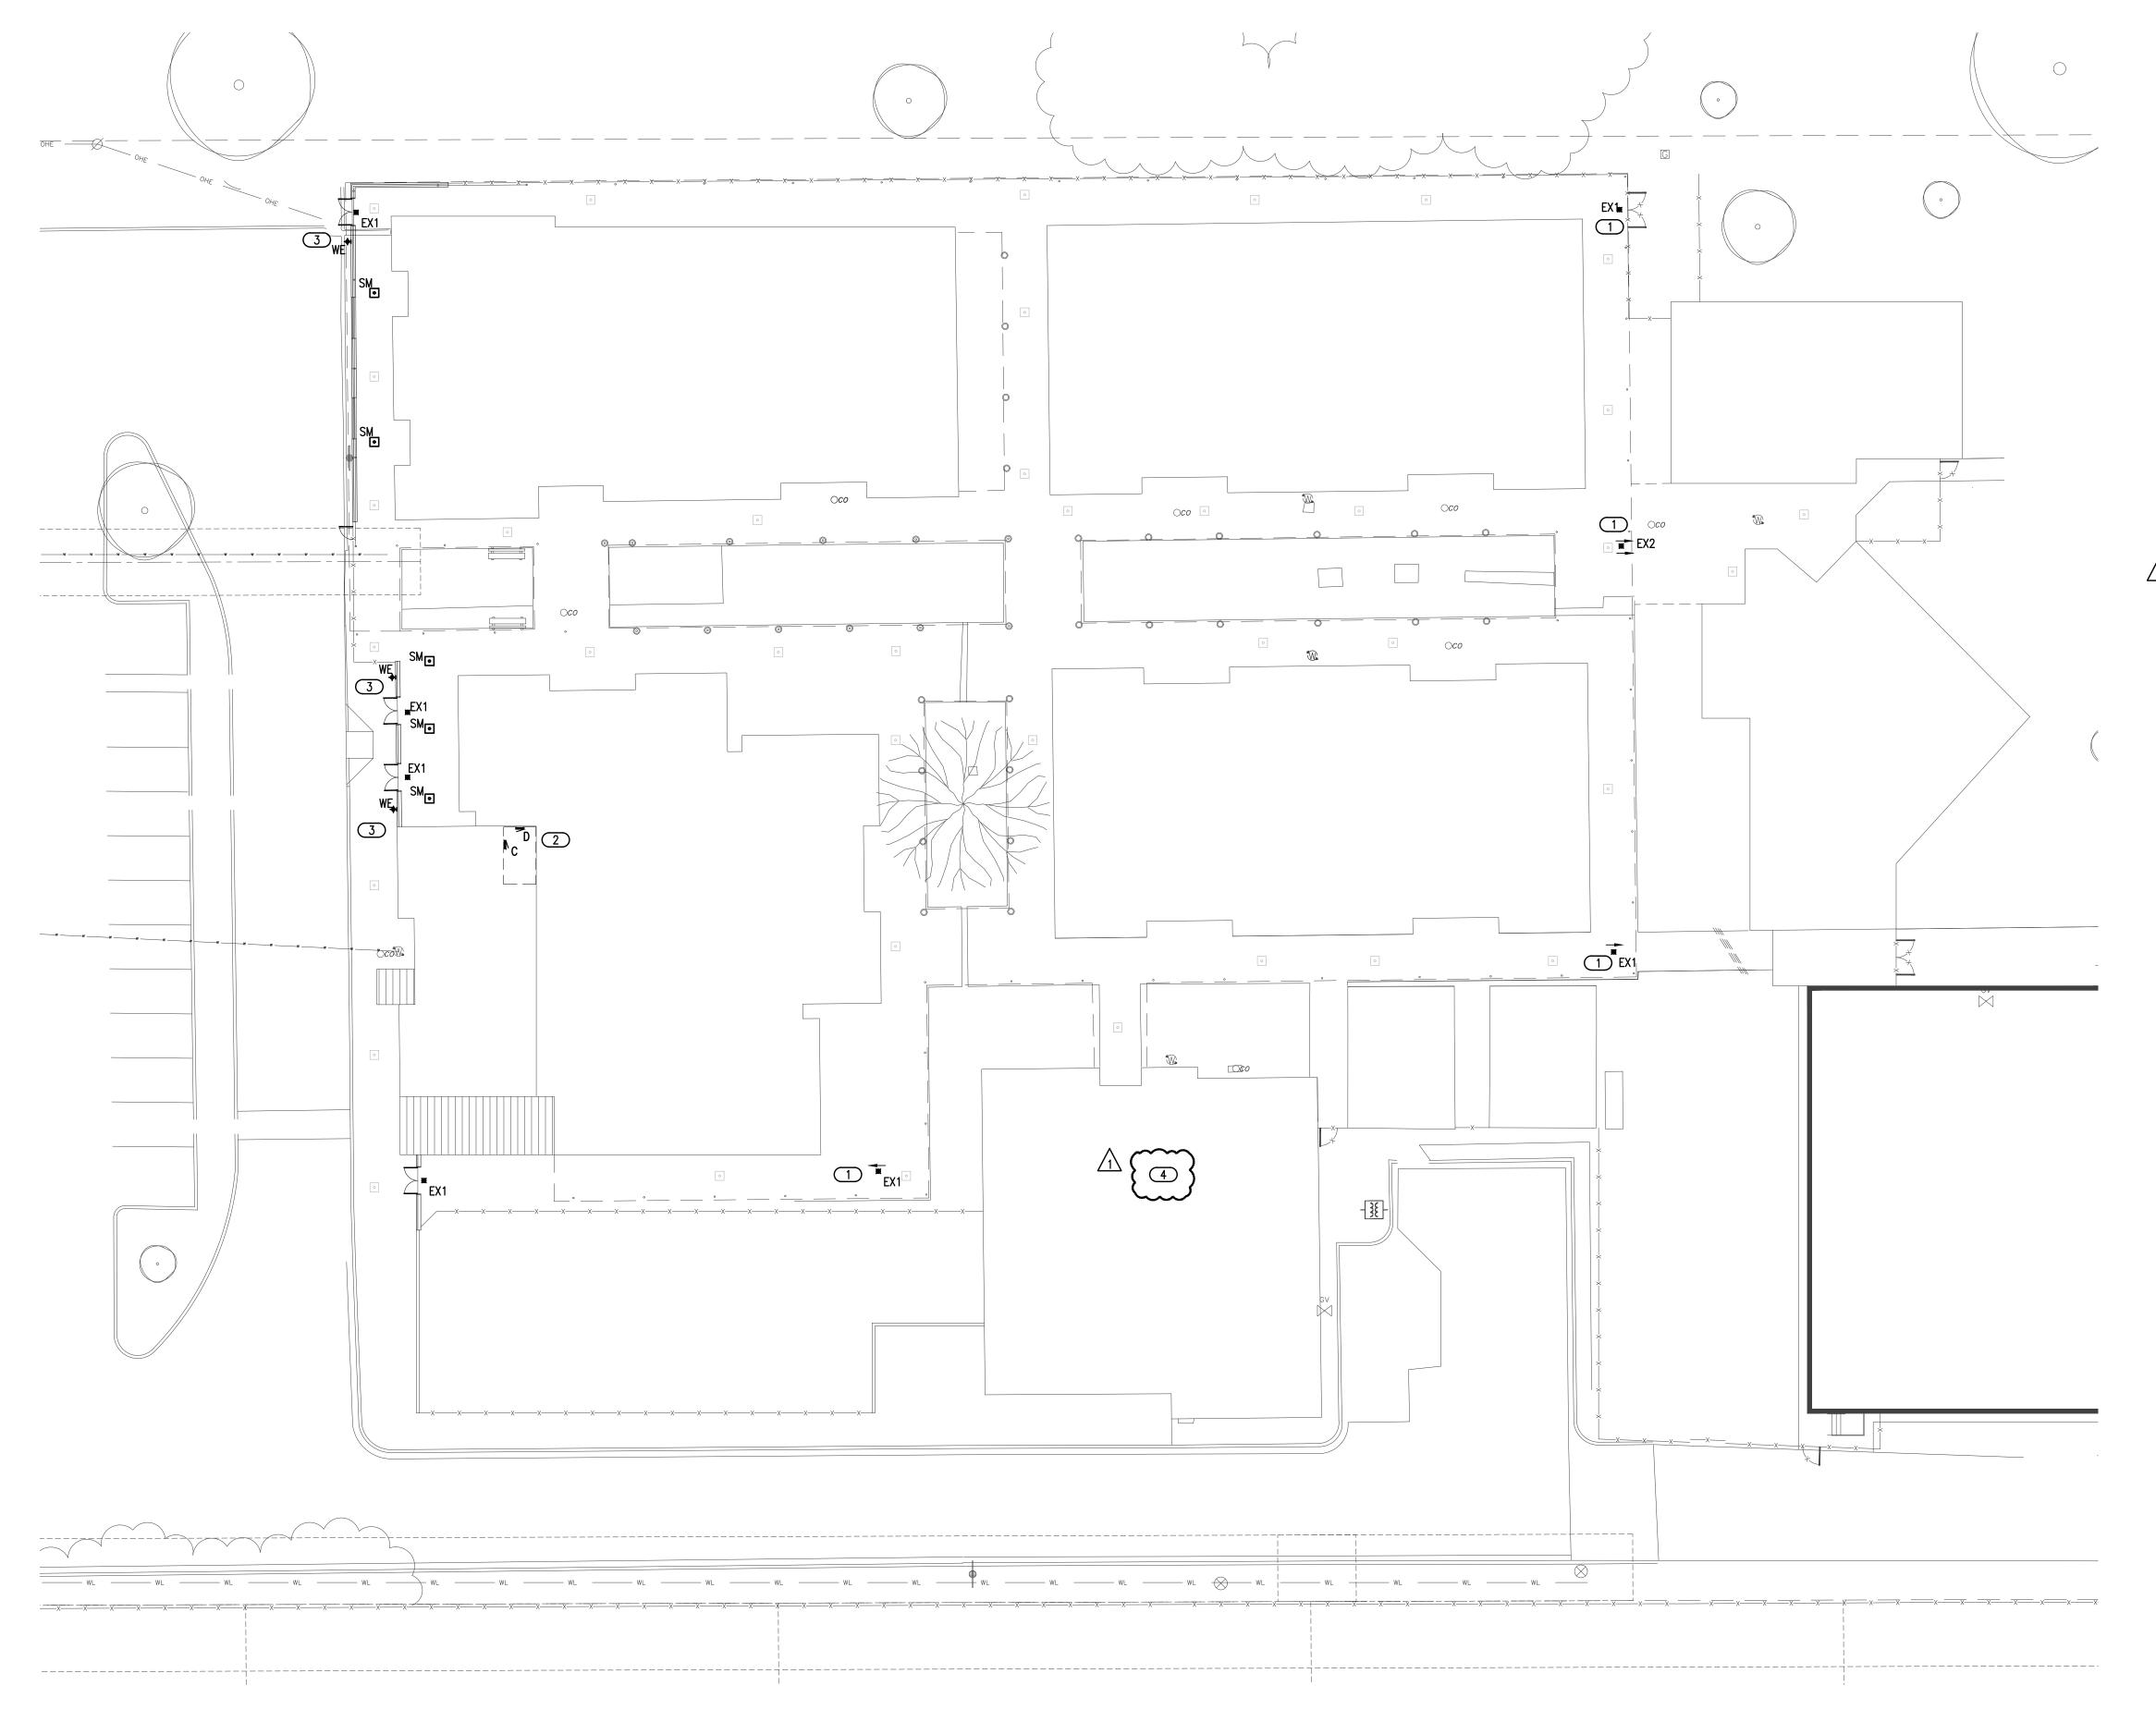


To: Mike Abla, Clay Griffin

This C	onstruction Bulletin is issued to:
<u>X</u>	Offer additional information for clarification or supplemental drawings for layout
	assistance.
	Request cost and time impact to initiate a change to the Contract Documents. Owner
	approval is required, do not commence with revisions unless directed in writing. Avoid
	Work in areas that may be affected by proposed change until approved or rejected.
	Once approved, forward Change Order documentation as required by the Contract
	Documents.
	Direct a required change in the Contract Documents. Proceed with change(s) as
	indicated. Forward Change Order documentation as required by the Contract
	Documents.
	Response to RFI

Item No.	Description	Attachment
1	Refer to clouds and deltas for changes.	E-100
2	Refer to clouds and deltas for changes.	T100
3	Refer to clouds and deltas for changes.	T101
4	Refer to clouds and deltas for changes.	T401

END OF CB-10



LIGHTING GENERAL NOTES

- CONNECT BATTERY PACKS TO UNSWITCHED HOT OF LOCAL LIGHTING CIRCUIT.
- COORDINATE WITH THE ARCHITECT, OWNER, AND ASSOCIATED TRADES FOR THE EXACT HEIGHT/LOCATION OF EXTERIOR MOUNTED LIGHTING FIXTURES PRIOR
- LABEL SWITCH PLATES AND J-BOXES WITH CIRCUIT PER SPECS.
- ALL NEW DEVICES TO BE GRAY UNLESS OTHERWISE NOTED.
- ALL NEW LIGHTING TO BE CONNECTED TO EXISTING EXTERIOR LIGHTING CIRCUITS, UNLESS OTHERWISE NOTED IN DRAWINGS. EC TO DETERMINE PEAK LOAD ON PANEL AND REPORT ANY ANOMALIES TO THE ARCHITECT AND ENGINEERING BEFORE PROCEEDING.
- PROVIDE NEW LIGHTING CONTACTOR. NEW LIGHTS SHALL BE CONTROLLED BY CONTACTOR TO INTERLOCK WITH EXISTING LIGHTING CONTROLS. EC SHALL FIELD INVESTIGATE AND REPORT ANY ANOMILIES TO THE ARCHITECT AND ENGINEER PRIOR TO PROCEEDING.

KEYED NOTES

1 NEW EXIT SIGN TO BE CEILING MOUNTED AND TO BE PLACED UNDER

2 APPROXIMATE LOCATION OF EXISTING PANELS. EC TO FIELD VERIFY EXACT LOCATION AND EXISTING CONDITIONS.

3 EC TO PROVIDE NEW 120V CONNECTION FOR NEW WALL PACKS. 4 EC TO PROVIDE NEW 120V DEDICATED CONNECTION FOR NEW ACCESS CONTROL PANEL. NEW ACCESS CONTROL PANEL TO BE LOCATED NEXT TO EXISTING ACCESS CONTROL PANEL. COORDINATE EXACT LOCATION WITH LOW VOLTAGE CONTRACTOR AND OWNER ON SITE. EXTEND CIRCUITING FROM NEAREST 120V PANEL.



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February 2025

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RED OAK **ELEMENTARY SCHOOL** SECURITY UPGRADES



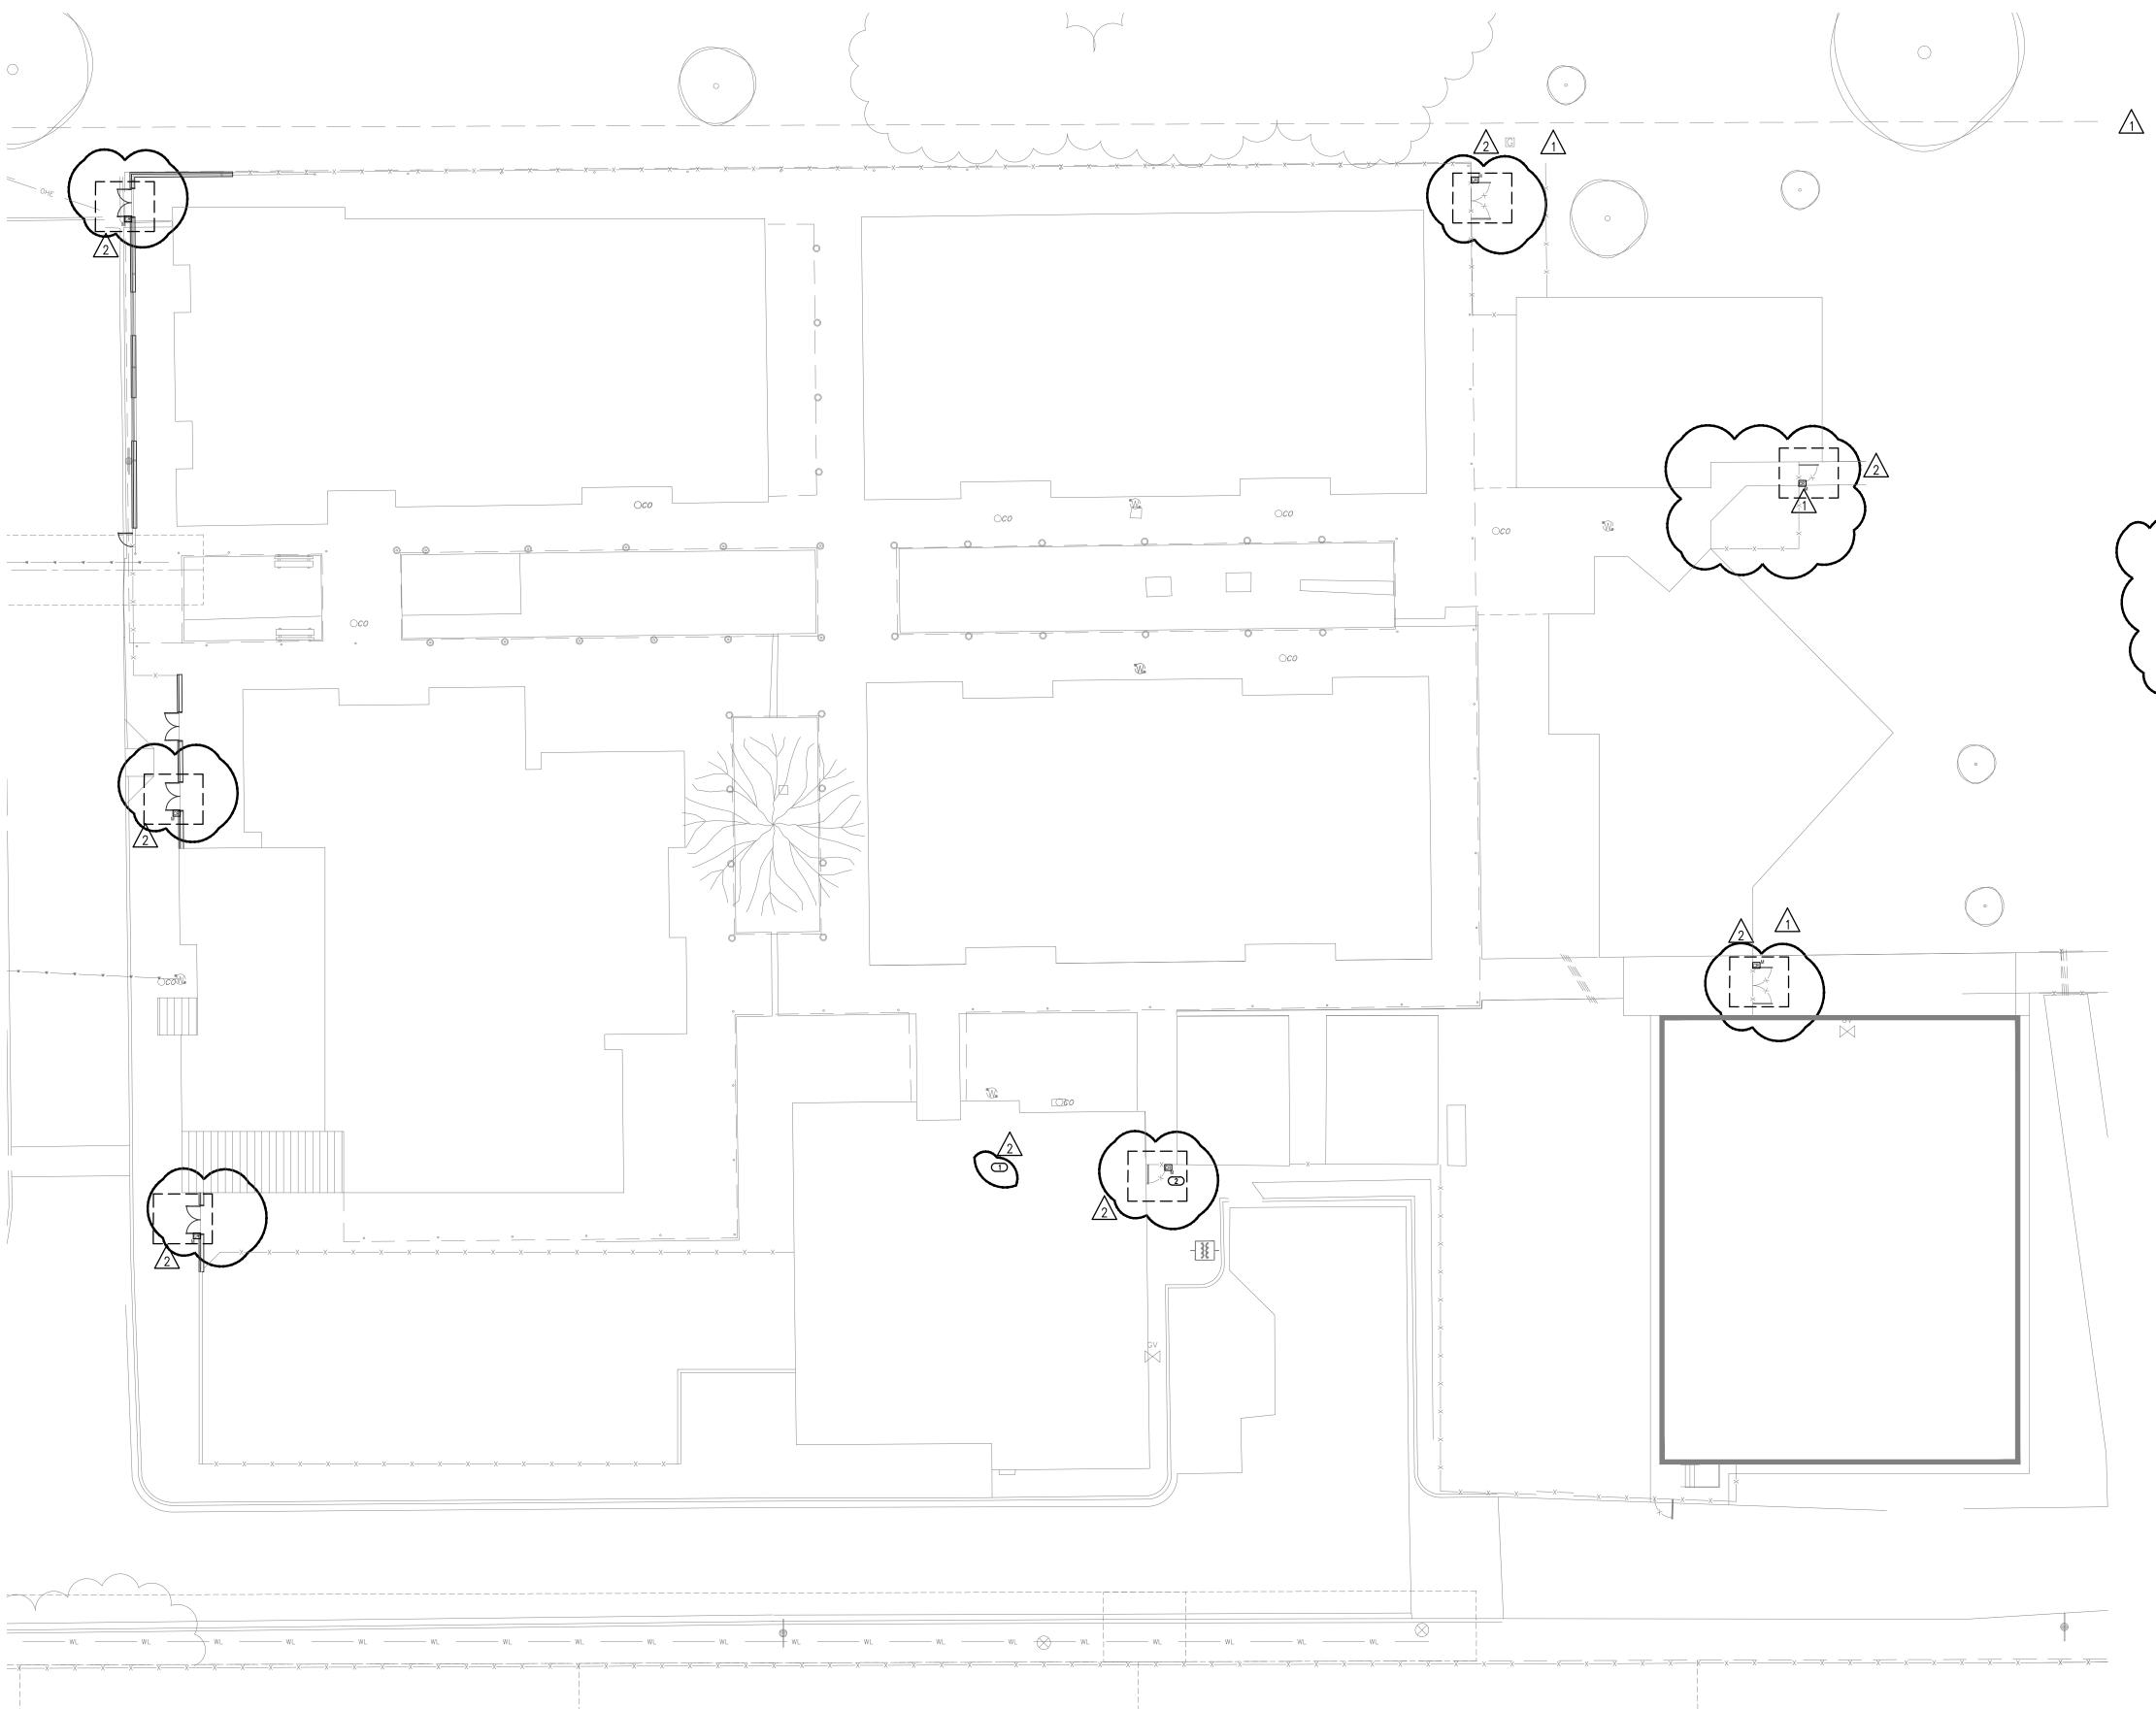
Salas O'Brien Project Number: 2024-02321

Expiration Date : 6/30/2023

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ELECTRICAL SITE PLANSCALE: 1" = 20'-0"



TECHNOLOGY SITE PLAN

SCALE: 1" = 20'-0"

GENERAL NOTES

A. REFERENCE ARCHITECTURAL PLANS FOR ADDITIONAL DOOR/GATE INFORMATION

ALL ACCESS CONTROL AND INTRUSION DEVICES SHALL CONNECT TO CONTRACTOR PROVIDED KEYSCAN CONTROLLER AND DSC ZONE EXPANDER AND POWER SUPPLY. REFERENCE TECHNOLOGY COMPOSITE PLANS FOR LOCATIONS

FIRE ALARM

FIRE ALARM SYSTEM IS A PERFORMANCE BASED PER SHEET SPECIFICATIONS. CONTRACTOR TO REFERENCE SPECIFICATIONS FOR ADDITIONAL INFORMATION.

B. A LICENSED FIRE ALARM PLANNING SUPERINTENDENT CERTIFIED TO A MINIMUM LEVEL 3, IN THE SUBFIELD OF FIRE ALARM SYSTEMS THROUGH THE NATIONAL INSTITUTE FOR CERTIFICATION IN ENGINEERING TECHNOLOGIES (NICET), SHALL PROVIDE PLANS AND CALCULATIONS FOR A MANUAL AND AUTOMATIC FIRE DETECTION AND ALARM SYSTEM TO COMPLY WITH THE BUILDING SPACE LAYOUT, BUILDING OCCUPANCY, CURRENT NFPA 72, LOCAL AND STATE CODE REQUIREMENTS, AND THE FIRE ALARM AND DETECTION SYSTEM SPECIFICATIONS.

FIRE ALARM SYSTEM TO BE UPGRADED. EXISTING BUILDING(S) AND RENOVATION AREA SHALL BE COVERED BY UPGRADED SYSTEM.

KEYED NOTES

1 ICONTRACTOR TO PROVIDE AND INSTALL NEW 2-DOOR ACCESS CONTROL PANEL ADJACENT TO EXISTING ACCESS CONTROL PANEL IN THIS BUILDING.

2 'M' SUBSCRIPT INDICATES MULLION/POST MOUNTED CARD READER.
TYPICAL FOR ALL SHOWN.

A

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NY
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February 2025
date

2
02/20/25 CB-10
revisions

06/19/24 ADDENDUM 02

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RED OAK
ELEMENTARY SCHOOL
SECURITY UPGRADES

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T100

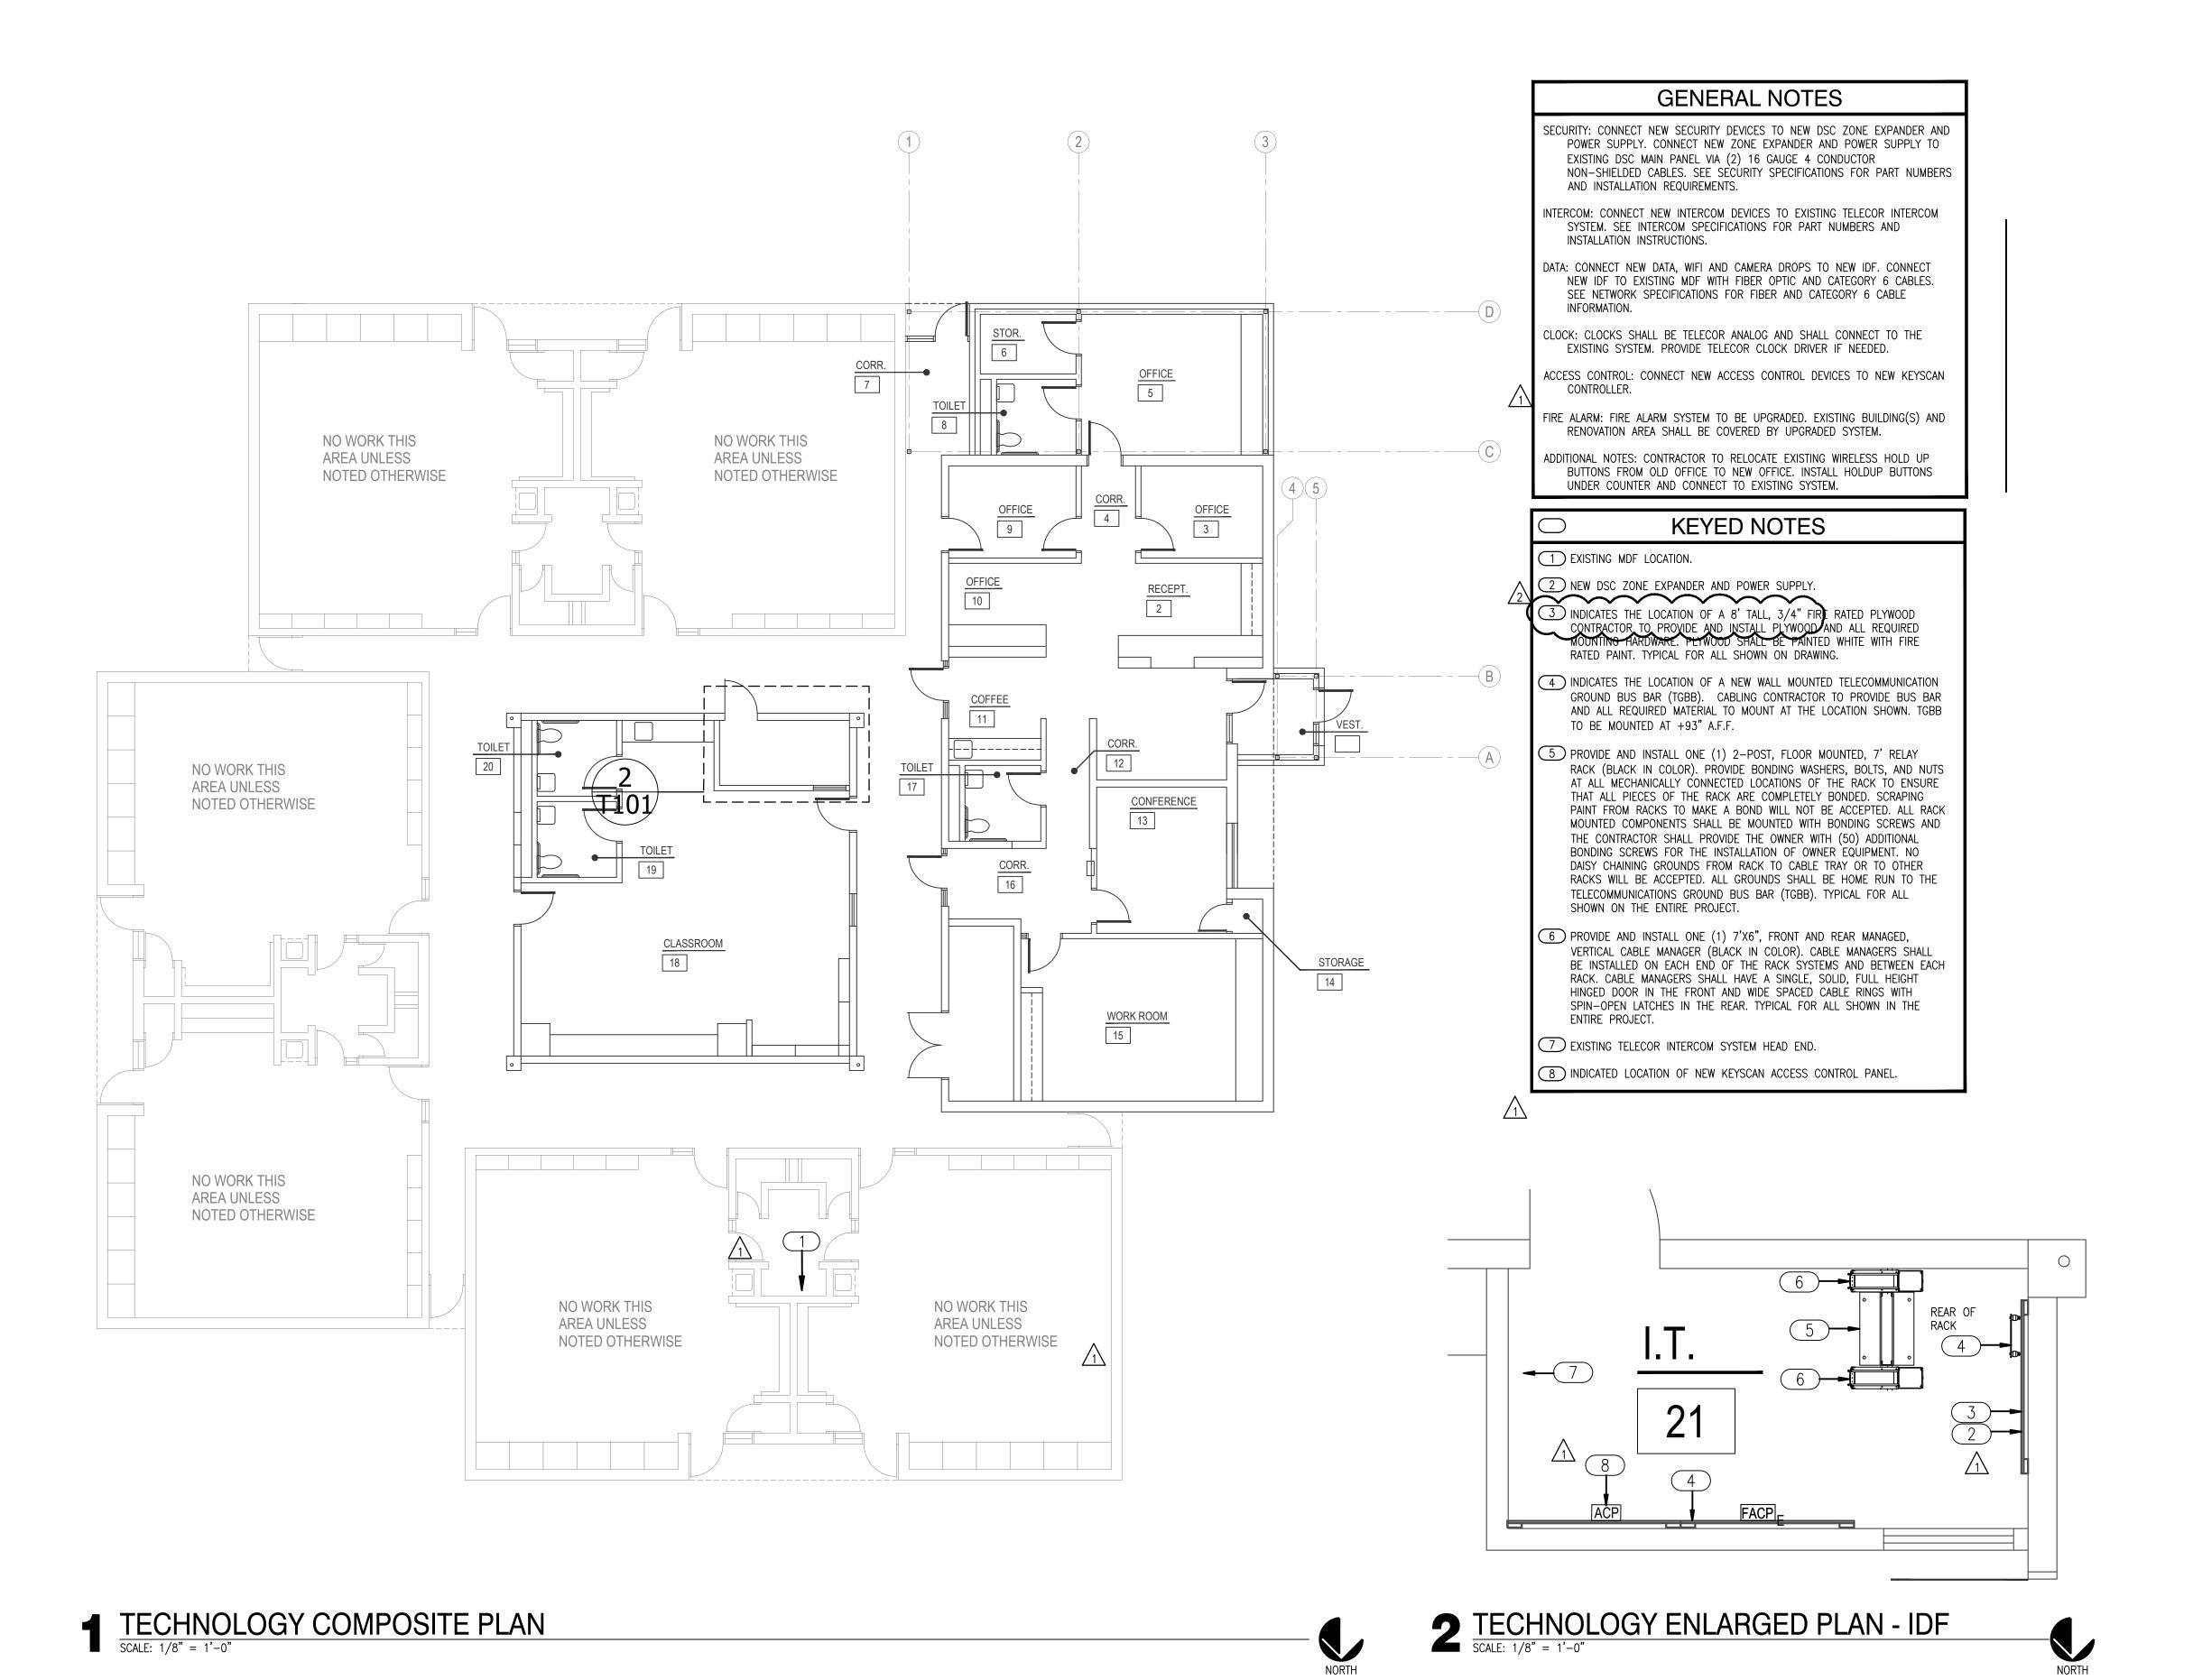


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RED OAK ELEMENTARY SCHOOL SECURITY UPGRADES

sheet no:

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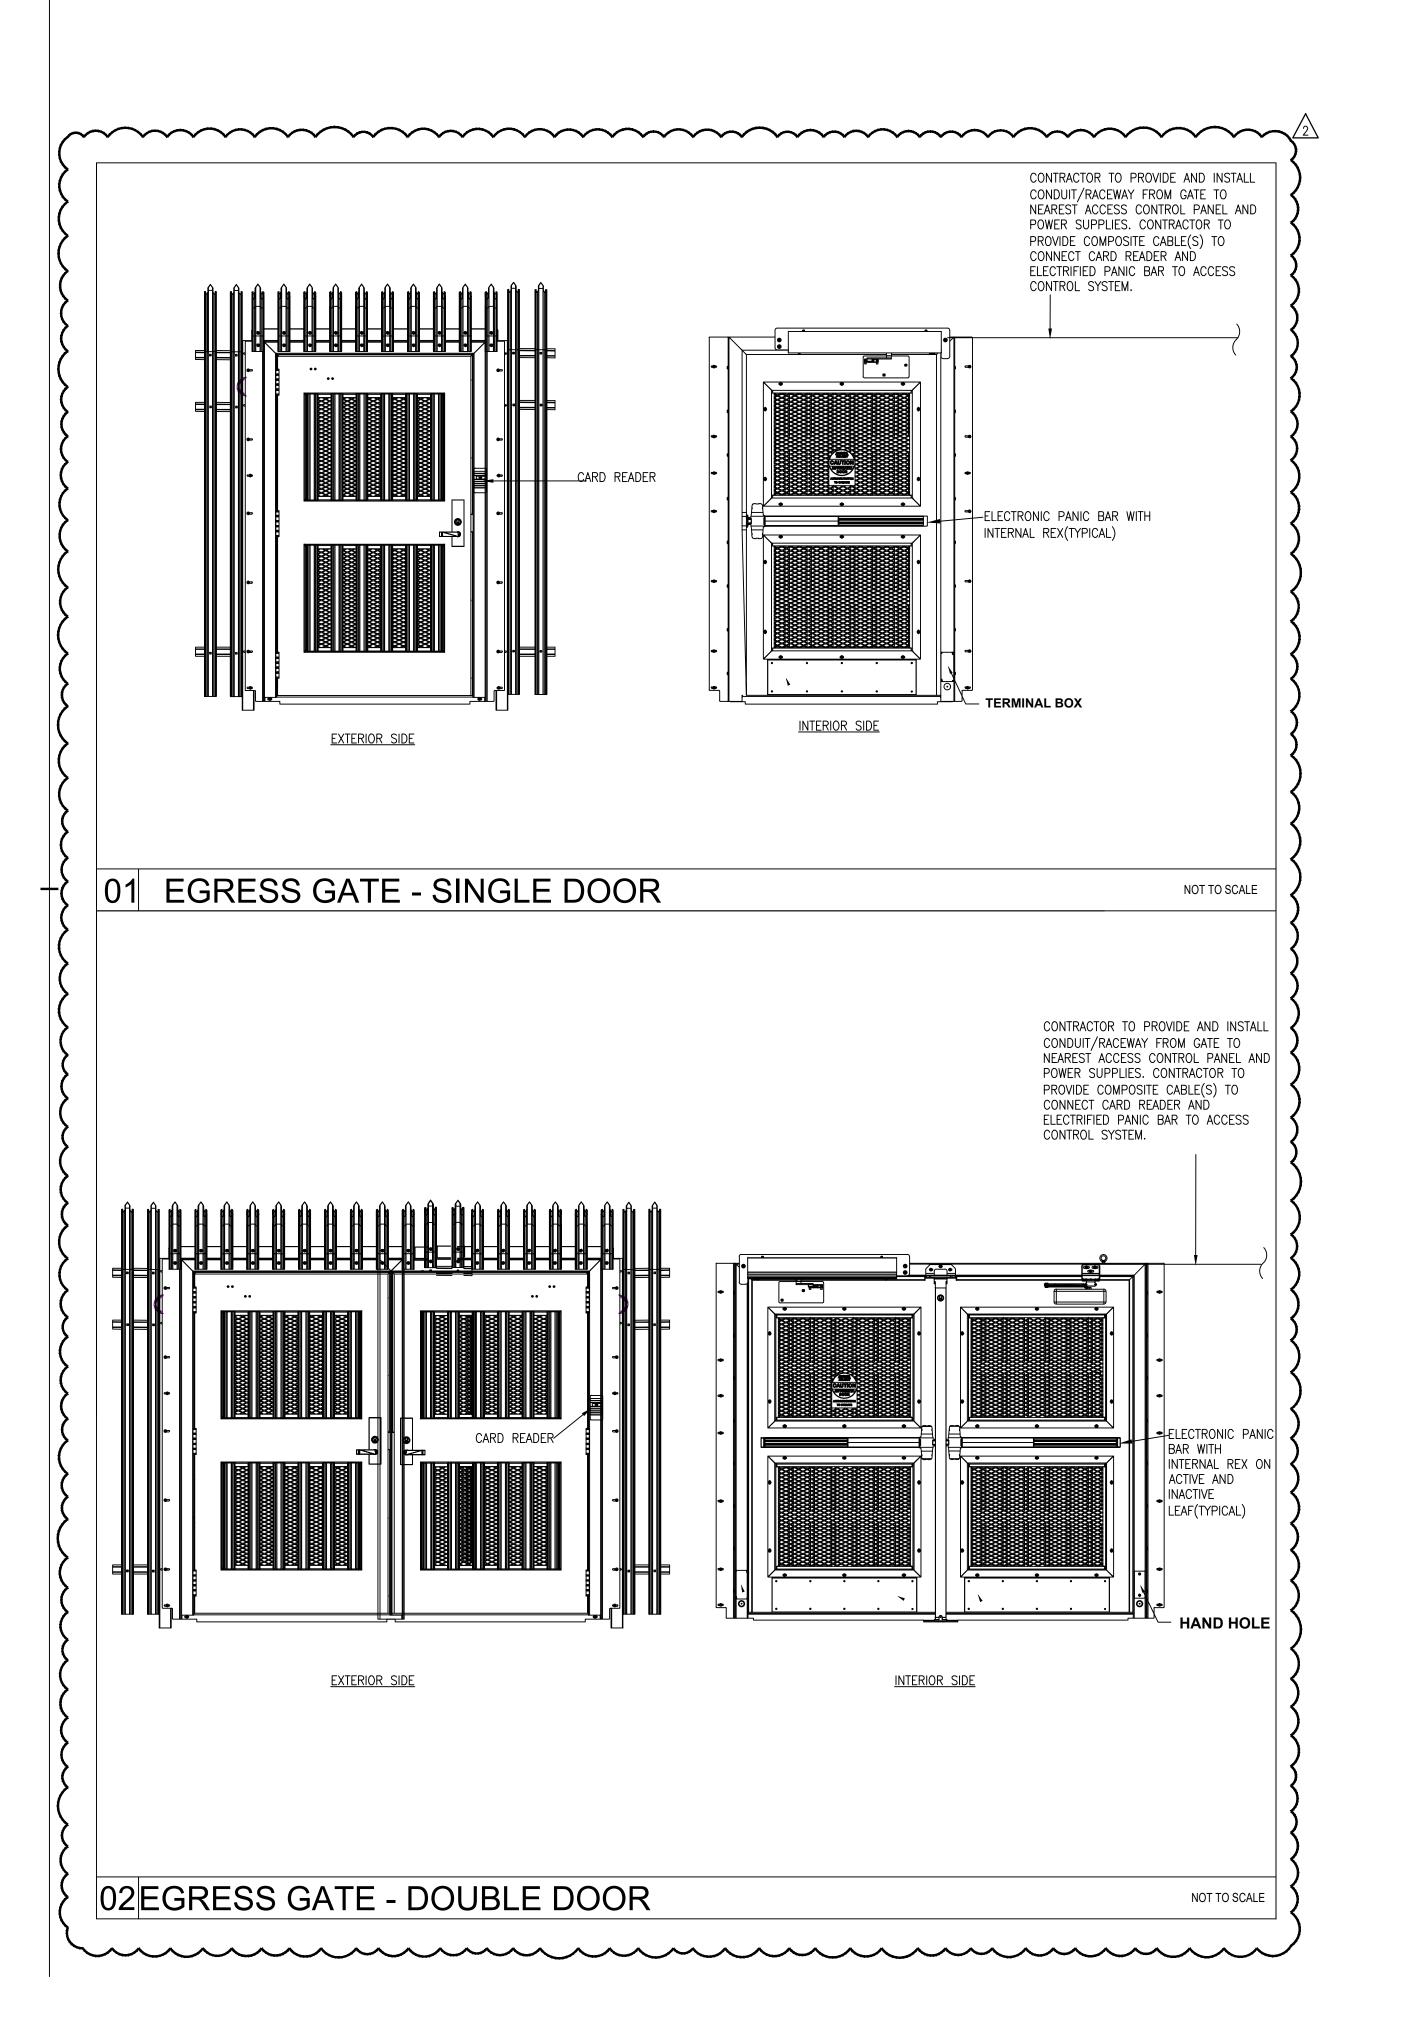


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RED OAK
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SECURITY UPGRADES

sheet no:

T401



Salas O'Brien Project Number: 2024-02321

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