## MOORE PUBLIC SCHOOLS RED OAK ELEMENTARY SCHOOL – SECURITY UPGRADES AND CAMPUS ENCLOSURE


Moore Public Schools - Moore, Oklahoma AGP - Moore, Oklahoma

#### **CONSTRUCTION BULLETIN NO. 9**

December 17, 2024

- 1. AT EXISTING CORRIDORS, REMOVE EXISTING ACOUSTICAL CEILING AND GRID, EXISTING CARPET TILE/FLOORING, WALL BASE, WINDOWS BETWEEN CORRIDOR AND ORIGINAL INTERIOR WORK ROOM, LIGHT FIXTURES, ETC. AS INDICATE ON SHEET A100a. REMOVE ALL WALL MOUNTED ITEMS TO BE SALVAGED (CONSULT WITH PRINCIPAL) AND PREPARE WALLS TO RECEIVE NEW PAINTER'S FINISH. REFER TO MECHANICAL AND ELECTRICAL DRAWINGS FOR ADDITIONAL DEMOLITION WORK.
- 2. AT AREAS INDICATED ON THE ATTACHED DRAWINGS, PROVIDE AND INSTALL NEW ACOUSTICAL CEILINGS AND GRID, NEW FLOORING AND WALL BASE, PAINT ALL WALLS, ETC. REFER TO MECHANICAL AND ELECTRICAL DRAWINGS FOR ADDITIONAL WORK.

END OF CONSTRUCTION BULLETIN NO. 9

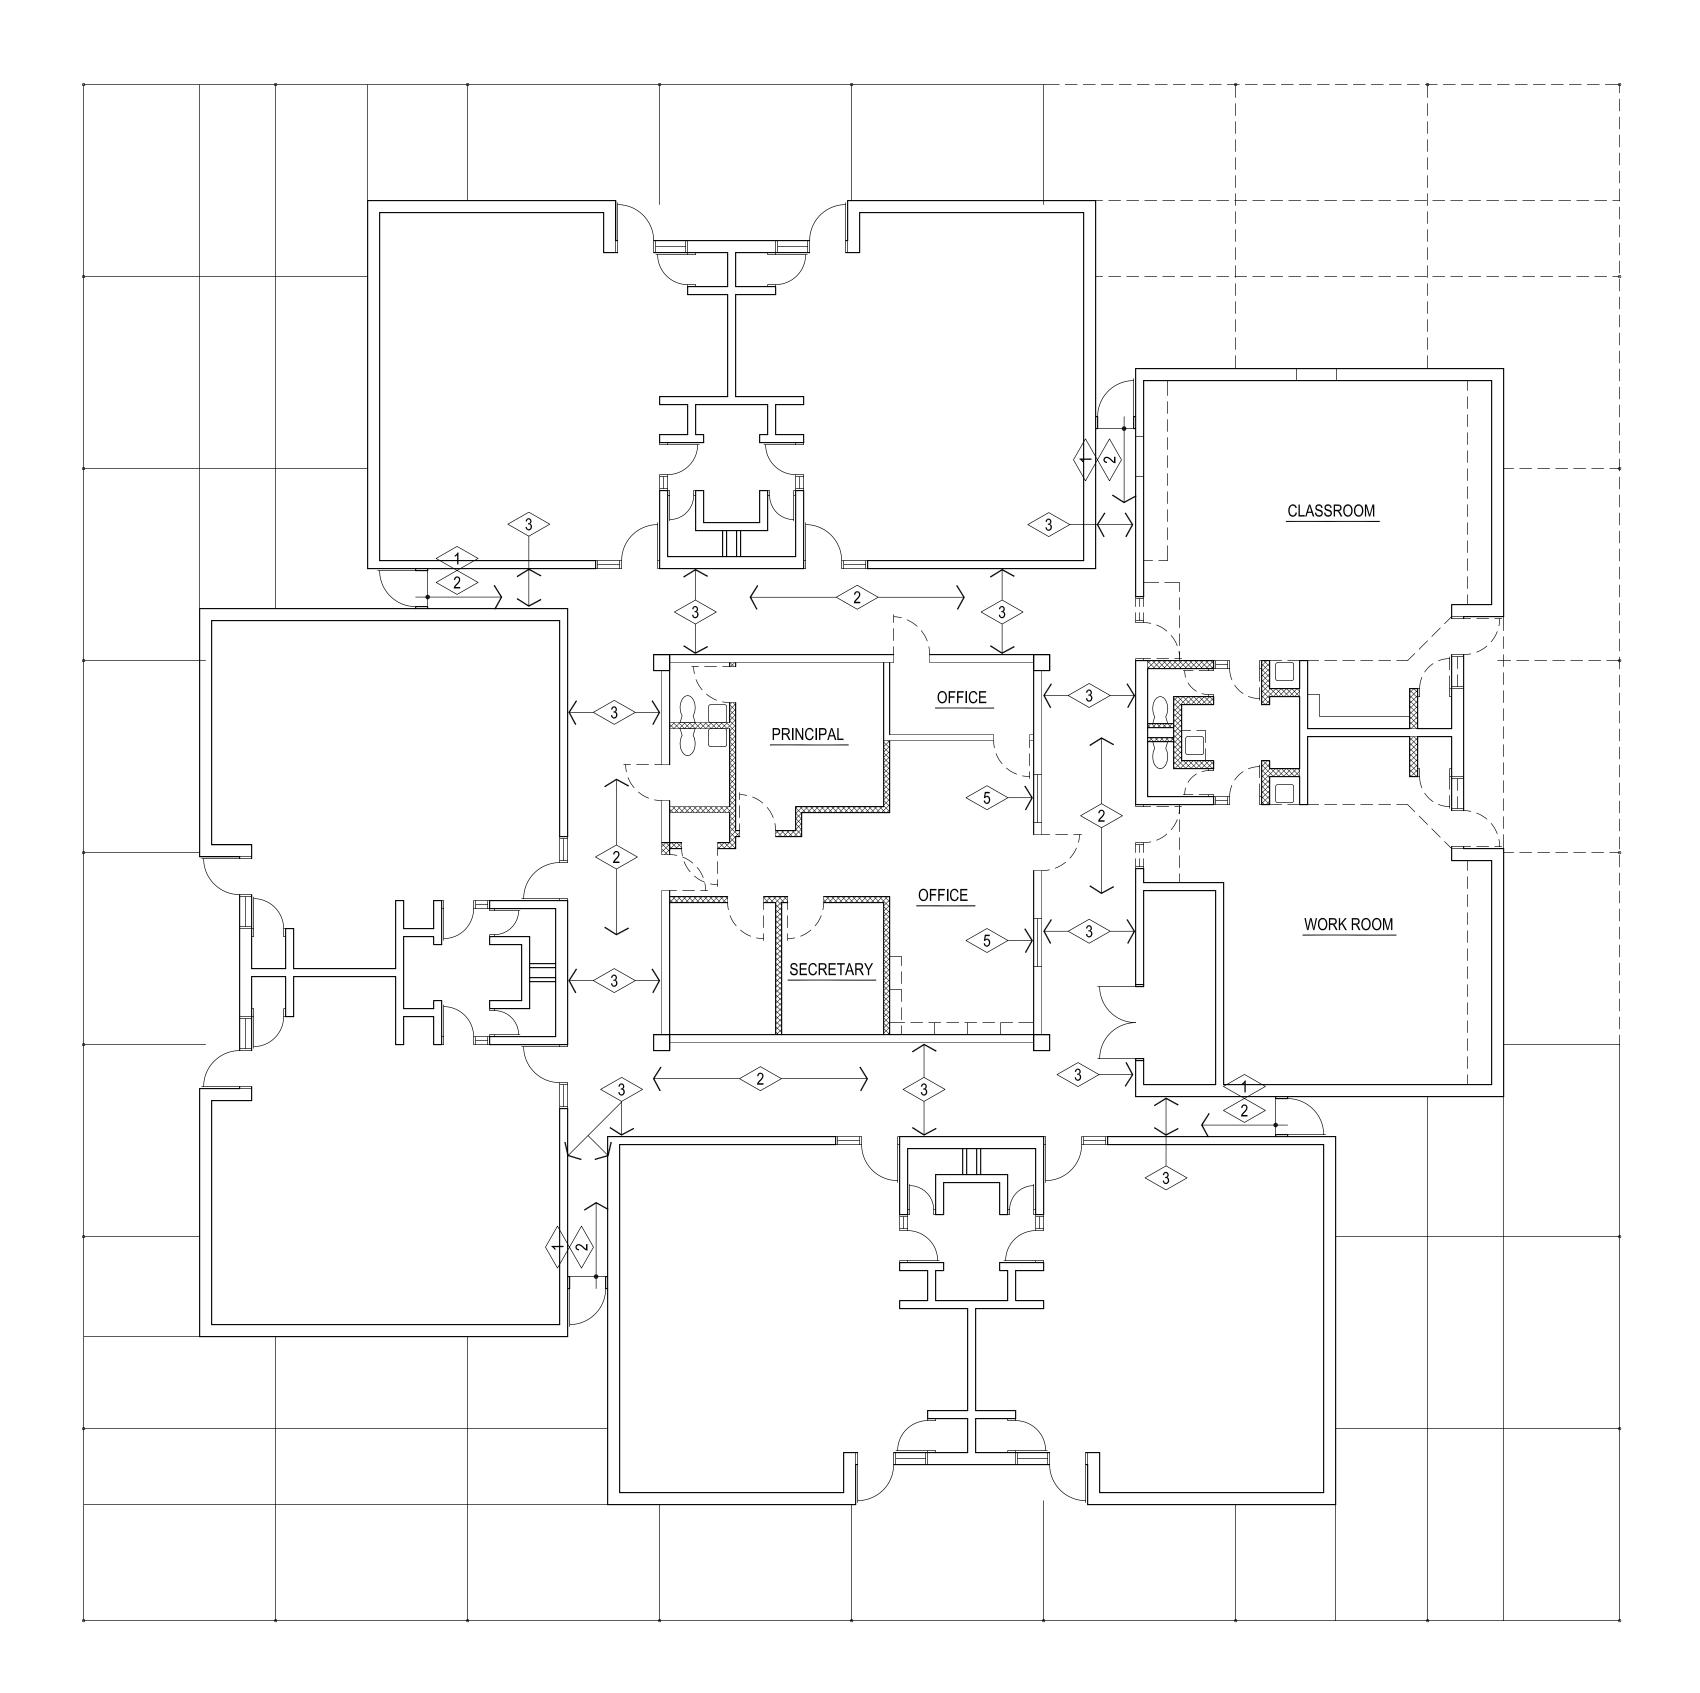



## ADDITIONAL DEMOLITION FLOOR PLAN

1/8" = 1'-0"

#### **GENERAL NOTES:**

- 1. FILL, GRADE, & PREPARE ALL EXCAVATED AREAS TO RECEIVE NEW SITE FEATURES.
- 2. CONTRACTOR TO VISIT SITE PRIOR TO PREPARING BID, & VERIFY ALL ITEMS TO BE DEMOLISHED. ANY ADDITIONAL ITEMS REQUIRING DEMOLITION THAT ARE NOT INCLUDED IN THESE DOCUMENTS SHOULD BE BROUGHT TO THE IMMEDIATE ATTENTION OF THE ARCHITECT AND INCLUDED IN THE BASE BID.
- 3. EXISTING UNDERGROUND UTILITY LOCATIONS & CONTOUR INFORMATION HAVE BEEN OBTAINED FROM THE BEST AVAILABLE SOURCES. THE CONTRACTOR SHALL FIELD VERIFY ALL EXISTING CONDITIONS PRIOR TO COMMENCING WORK & COORDINATE W/ ARCHITECT.
- 4. CONTRACTOR IS TO FIELD VERIFY ALL EXISTING ELEVATIONS PRIOR TO STARTING EARTHWORK AND ADJUST ACCORDINGLY AS DIRECTED BY THE ARCHITECT.
- DURING ALL EXISTING UTILITY REVISIONS TEMPORARY SERVICE IS TO BE PROVIDED @ ALL EFFECTED BUILDINGS.
- 6. ALL SALVAGEABLE ITEMS TO REMAIN OWNER'S PROPERTY & SHALL BE STORED OR DISPOSED OF AS PER OWNER'S INSTRUCTIONS.
- 7. CONSTRUCTION SHALL MEET ALL APPLICABLE CODES, ORDINANCES, REGULATIONS & STANDARDS REQUIRED BY THE CITY OF OKLAHOMA CITY, OKLAHOMA.
- 8. CONSTRUCTION SHALL MEET ALL APPLICABLE REQUIREMENTS OF THE AMERICANS W/ DISABILITIES ACT INCLUDING ANY SUPPLEMENTAL REQUIREMENTS BY THE CITY OF OKLAHOMA CITY, OKLAHOMA.
- 9. CONTRACTOR SHALL COORDINATE ACCESS TO SITE W/ OWNER PRIOR TO STARTING WORK. OBTAIN APPROVAL FROM OWNER FOR ON-SITE MATERIAL STORAGE, ETC. CONTRACTOR SHALL PROVIDE PROPER SEPARATION BTWN. WORK & STUDENTS.
- COORDINATE LOCATION OF CONSTRUCTION FENCE W/ ARCHITECT
   OWNER PRIOR TO STARTING WORK. RE 1C600 FOR EROSION
   CONTROL PLAN.

## **DEMOLITION NOTES:**

- REMOVE EXISTING CEILING GRID / GYP. BD. AND PREPARE ROOM TO RECEIVE NEW 2X2 LAY-IN / GYP. BD. CEILING
- REMOVE EXISTING CARPET TILE / FLOORING & WALL BASE & PREPARE EXISTING SLAB TO RECEIVE NEW.
- REMOVE ALL EXISTING WALL MOUNTED ITEMS TO BE SALVAGED.
  PREPARE EXISTING WALLS TO RECEIVE NEW PAINT
- REFER MECHANICAL, ELECTRICAL FOR ADDITIONAL WORK.
- REMOVE EXISTING WINDOW SYSTEM AND ASSOCIATED FRAMING AS REQUIRED TO INSTALL NEW METAL STUD IN-FILL W/ 5/8" FIRE RATED GYP. BD. EACH SIDE. MATCH EXISTING WALL THICKNESS.



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SALAS O'BRIEN

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MAY 2024

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MOORE PUBLIC SCHOOLS BOARD OF EDUCATION MOORE, OKLAHOMA




RED OAK
ELEMENTARY SCHOOL
SECURITY UPGRADES

sheet no

A100a

DEMOLITION FLOOR PLAN

OWNERSHIP USE OF DOCUMENTS:

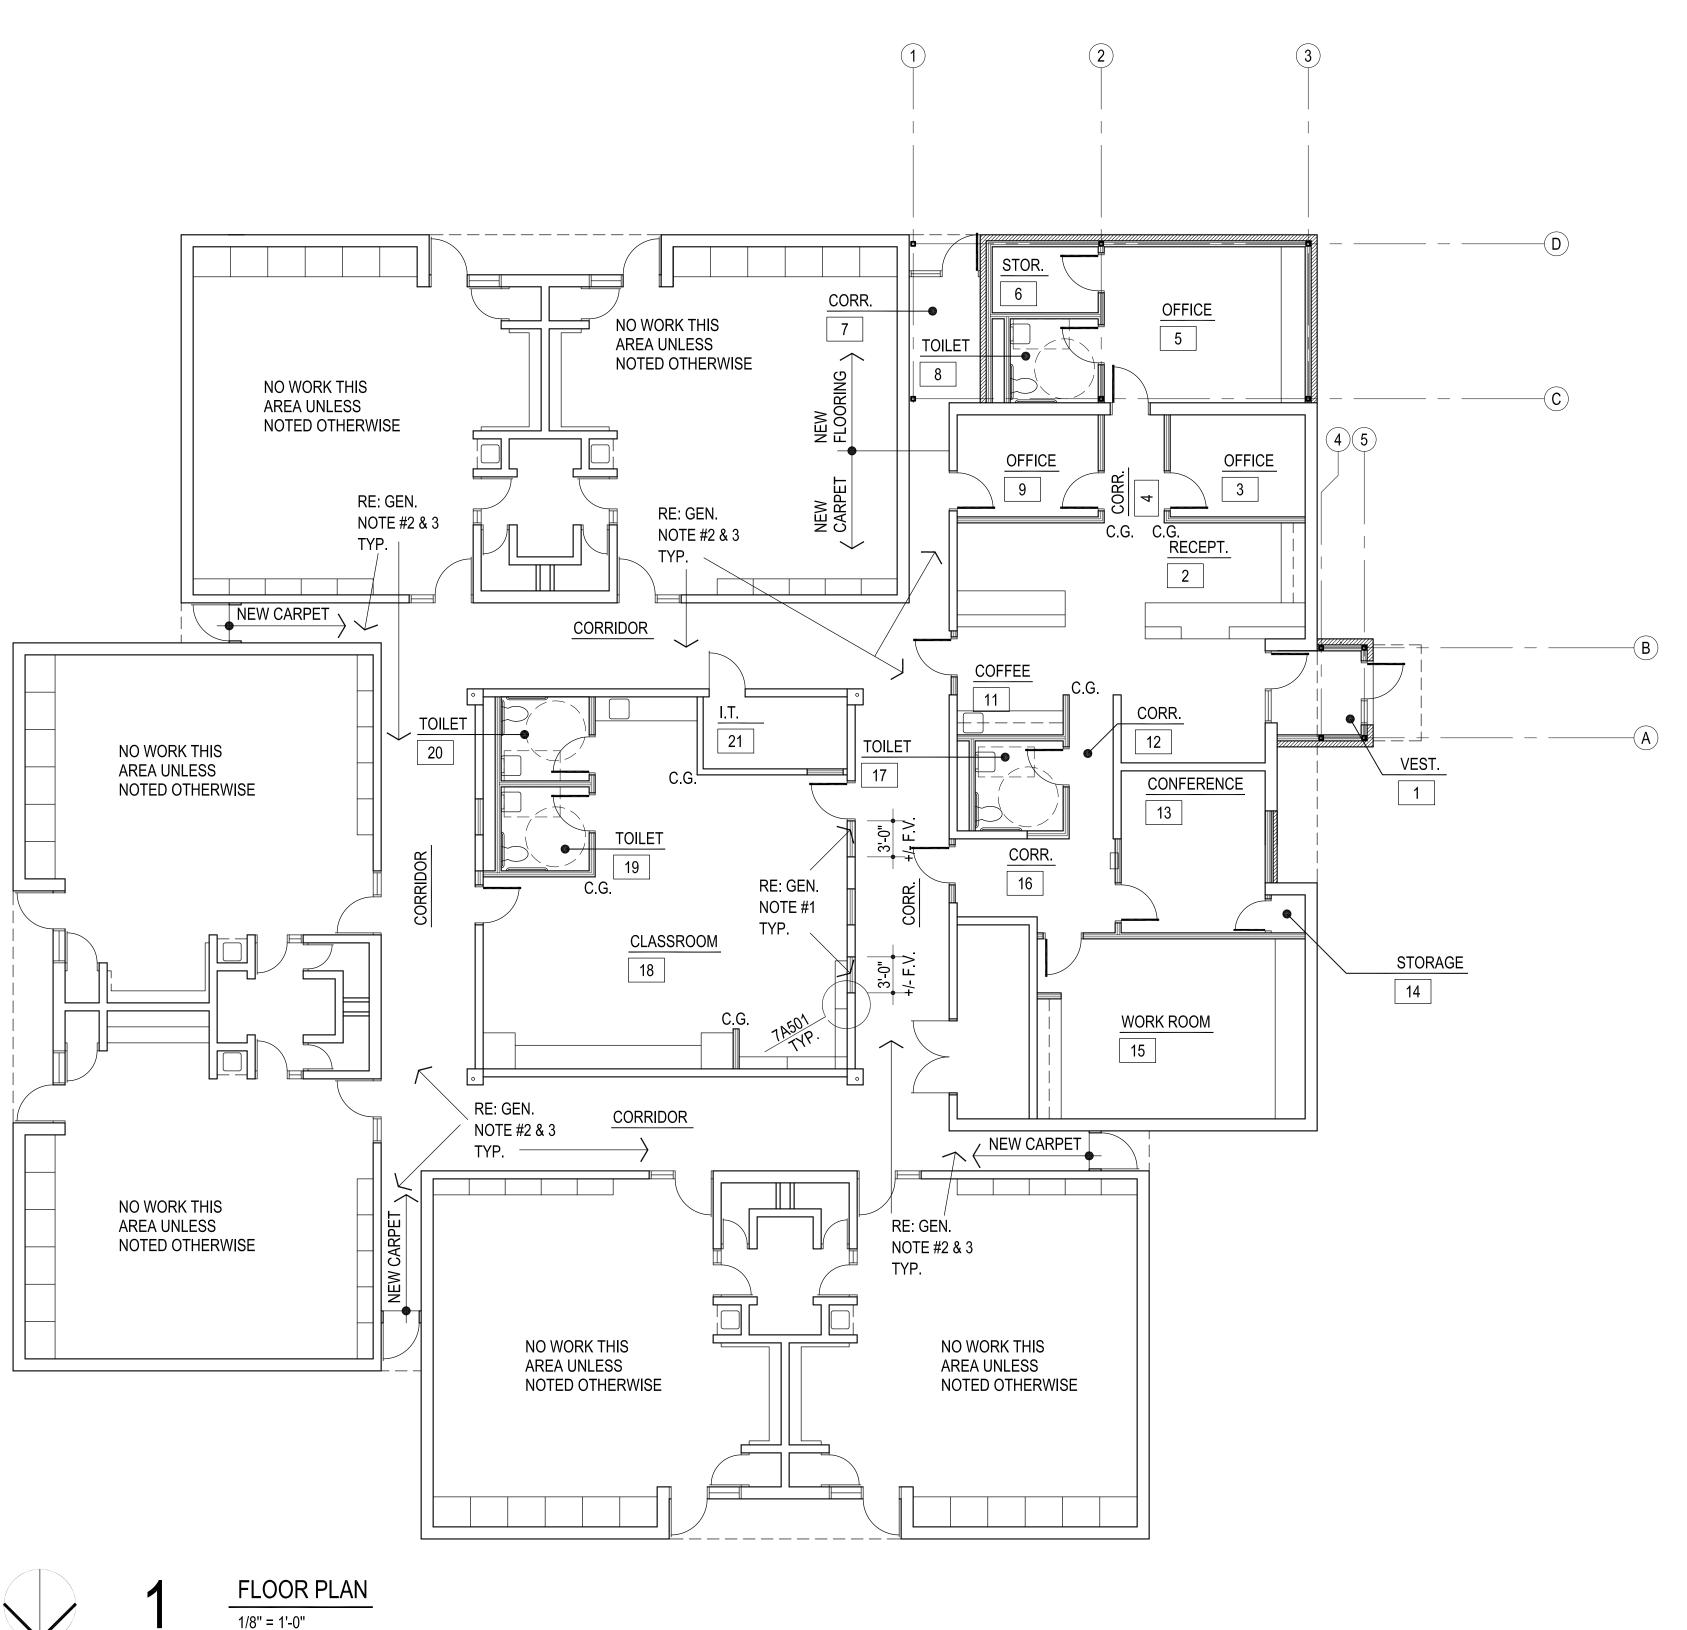




## GENERAL NOTES:

- 1. REMOVE EXISTING WINDOW FRAME SYSTEM AND PREPARE OPENING TO RECEIVE NEW STUD IN FILL WITH GYP. BD EACH SIDE MATCH EXISTING WALL THICKNESS COORDINATE WITH ARCHITECT. PAINT ENTIRE WALL AT EXISTING CORRIDOR SIDE. SHERWIN-WILLIAMS - SW7008 - ALABASTER
- 2. AT EXISTING CORRIDOR PROVIDE NEW CARPET INTERFACE FLOOR COLOR: 410-107025 NATURAL WITH NEW WALL BASE - ROPPE - 100 BLACK.
- 3. AT EXISTING CORRIDOR PREPARE EXISTING / NEW WALLS TO RECEIVE NEW PAINT. PAINT COLOR TO BE - SHERWIN-WILLIAMS - SW7008 - ALABASTER
- 4. REFER SHEET A102 FOR ADDITIONAL WORK.

NOTE: CONTRACTOR TO VERIFY THAT THE MOUNTING HEIGHTS OF ALL WALL MOUNTED FIXTURES (I.E. PLUMBING FIXTURES, GRAB BARS, MIRRORS, ETC.) MEET ALL APPLICABLE CODES & STANDARDS

### PRIOR TO INSTALLATION.

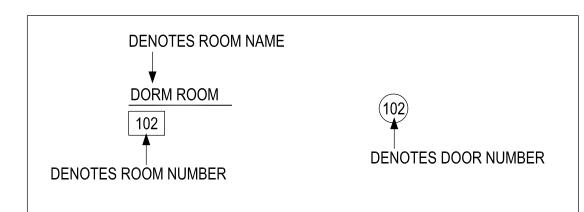




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1 CB-9

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**RED OAK ELEMENTARY SCHOOL** SECURITY UPGRADES


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FLOOR PLAN

OWNERSHIP USE OF DOCUMENTS:



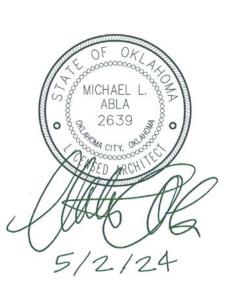

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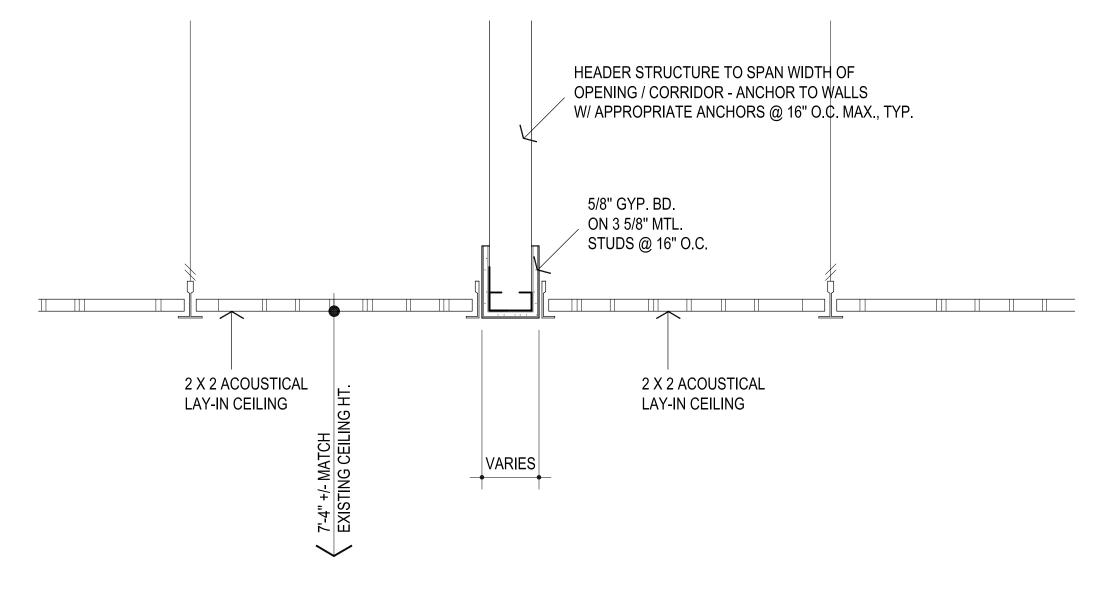
**RED OAK ELEMENTARY SCHOOL** SECURITY UPGRADES

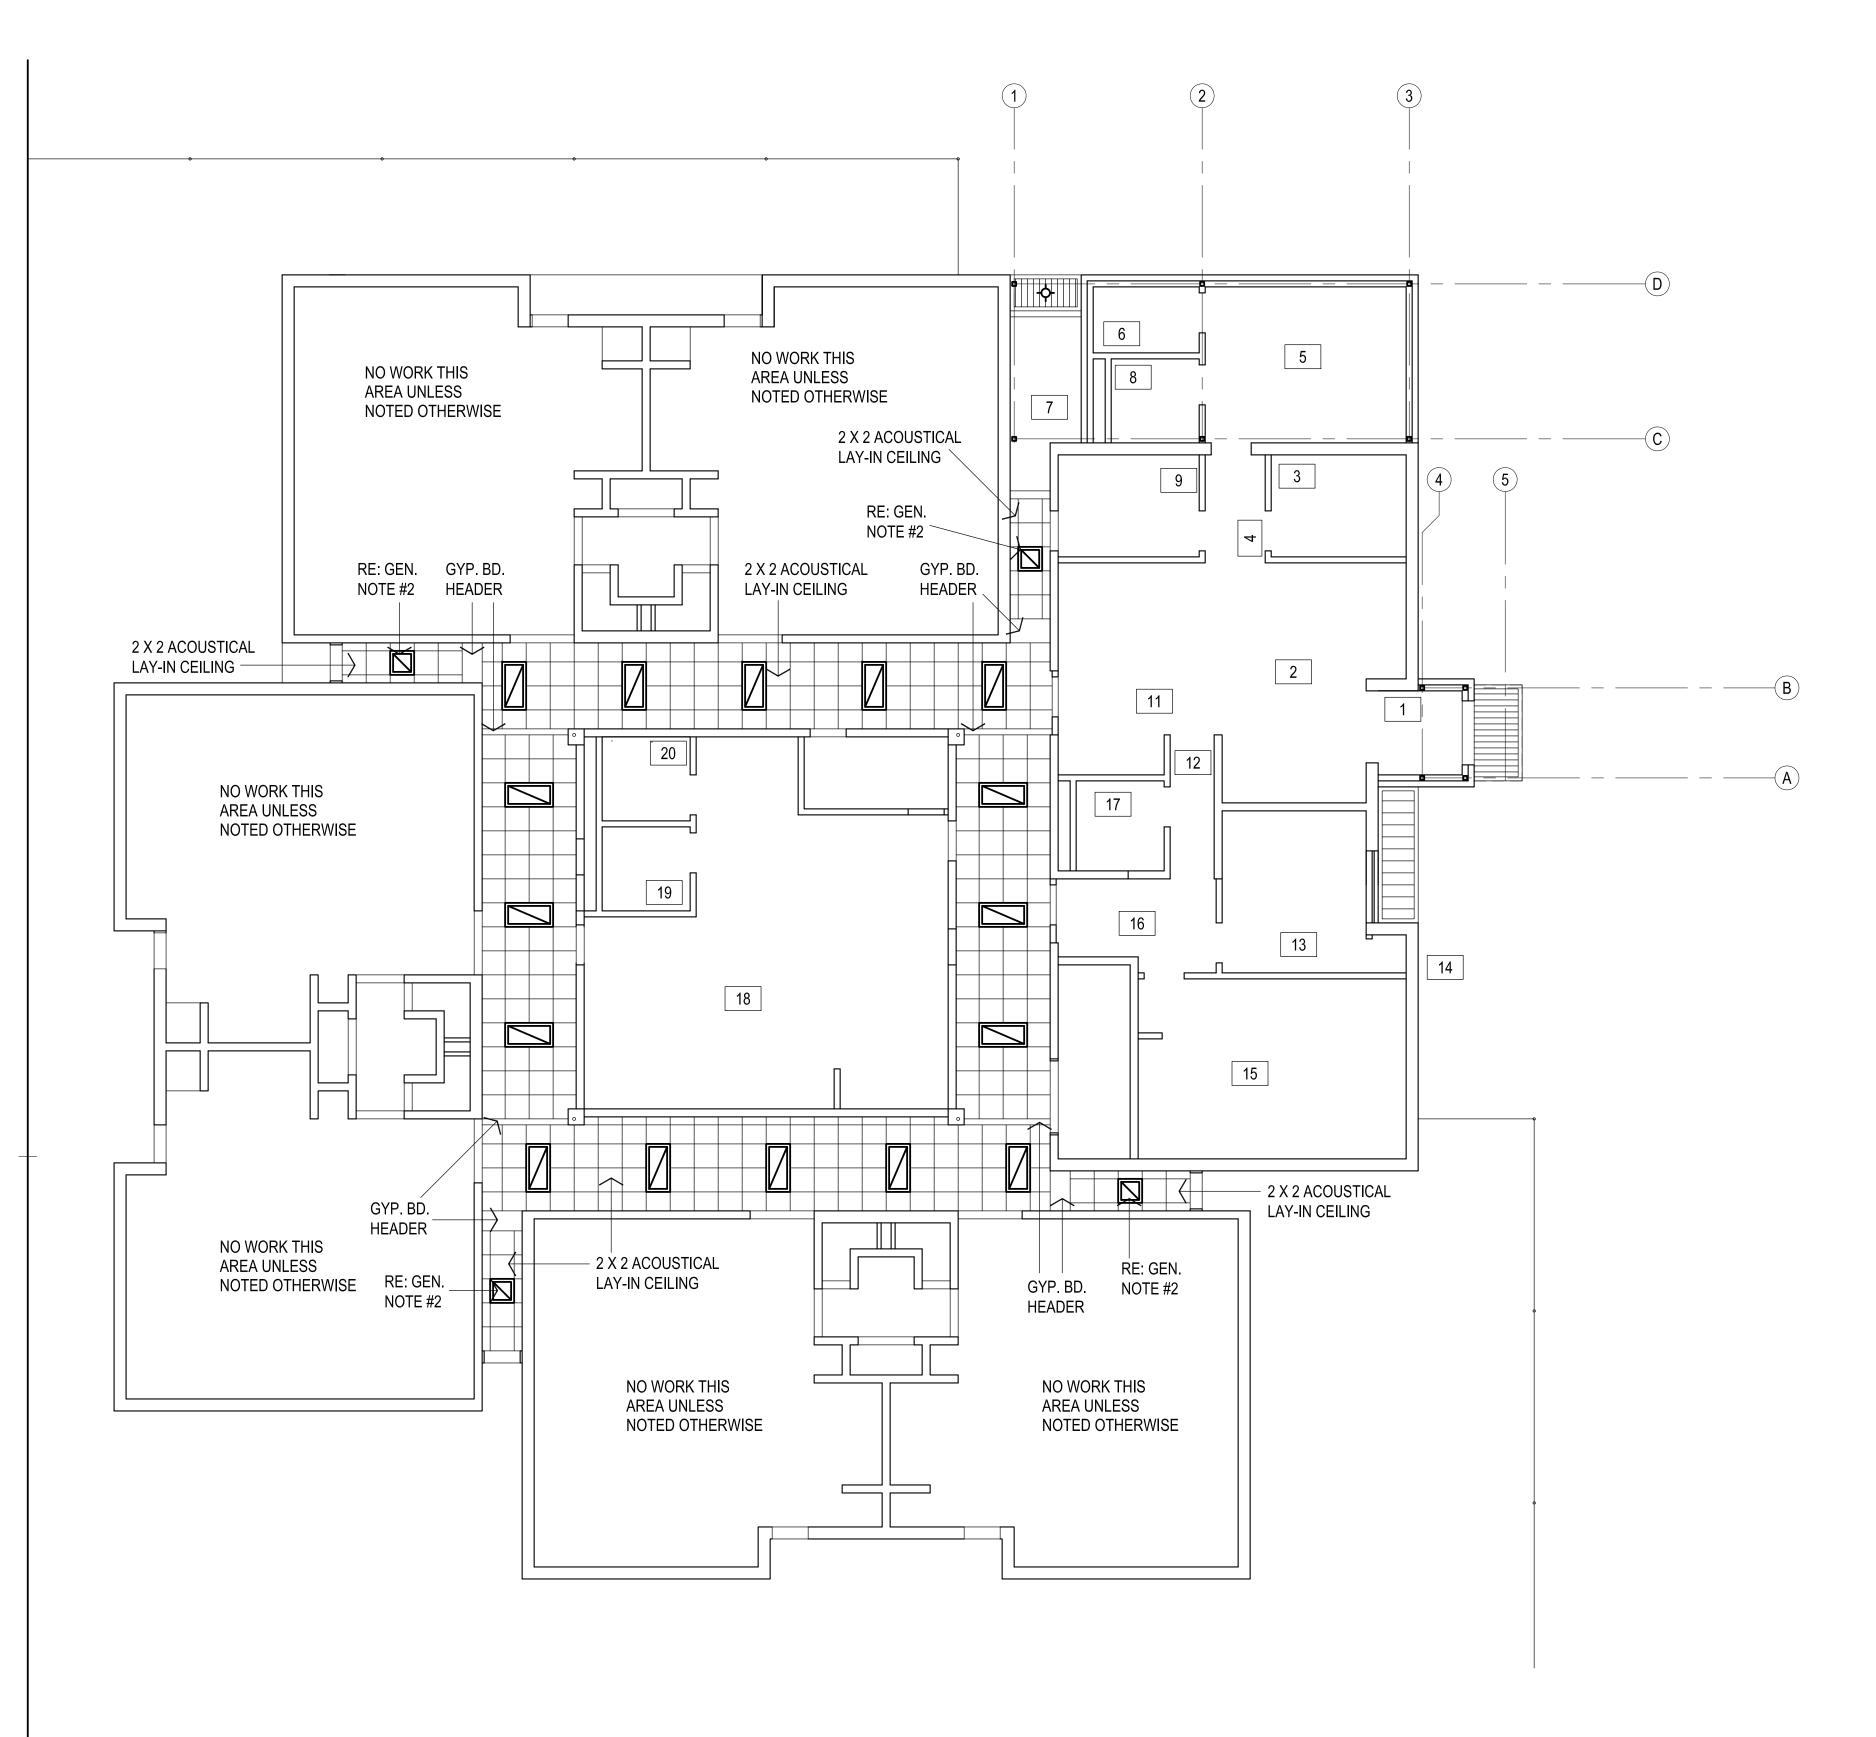1 ENTIRE SHEET

REFLECTED CEILING PLAN

OWNERSHIP USE OF DOCUMENTS:

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GYP. BD. HEADER 1 1/2" = 1'-0"



ADDITIONAL REFLECTED CEILING PLAN

1/8" = 1'-0"

LEGEND:

MECHANICAL OPENINGS

ELECTRICAL FIXTURES

CEILING MOUNTED SMOKE DETECTOR, RE: ELEC

NOTES

1. REFER MECHANICAL & ELECTRICAL FOR ANY ADDITIONAL CEILING MOUNTED FIXTURES

2. NEW 2X2 FIXTURE TO BE "SWAPPED" WITH 2X4 FIXTURE FROM ROOM# 3 & 9.



#### Construction Bulletin # 09

Client: Abla Griffin Partnership

Project Name: Red Oak Campus Renovation

Project Number: 2024-02321-00

December 16, 2024

Requested by: X Owner

\_\_\_ Contractor:

\_\_\_ Salas O'Brien:

To: Mike Abla, Clay Griffin



This C	onstruction Bulletin is issued to:
<u>X</u>	Offer additional information for clarification or supplemental drawings for layout
	assistance.
	Request cost and time impact to initiate a change to the Contract Documents. Owner approval is required, do not commence with revisions unless directed in writing. Avoid Work in areas that may be affected by proposed change until approved or rejected. Once approved, forward Change Order documentation as required by the Contract
	Documents.  Direct a required change in the Contract Documents. Proceed with change(s) as indicated. Forward Change Order documentation as required by the Contract Documents.  Response to RFI

Item No.	Description	Attachment
1	Refer to clouds and deltas for changes.	E000
2	Refer to clouds and deltas for changes.	ED101
3	Refer to clouds and deltas for changes.	E101
4	Refer to clouds and deltas for changes.	E601

#### **END OF CB-09**

		LIGHT FIXTURE SCHEI	DULE	
TYPE	SYMBOL	DESCRIPTION	MANUFACTURER	REFERENCE CATALOG #
A		2' X 4' LED RECESSED TOFFER. 38.79W, 4867 LUMENS, 3500K CCT. 80 CRI. 0-10V DIMMING.	LITHONIA	2GTL 4 48L GZ10 LP835
AE		2' X 4' LED RECESSED TROFFER. 38.79W, 4867 LUMENS, 3500K CCT. 80 CRI. 0-10V DIMMING, PROVIDE 90 MINUTE BATTERY BACKUP.	LITHONIA	2GTL 4 48L GZ10 LP835 EL14L
BE		2' X 2' LED RECESSED TOFFER. 90 MINUTE BATTERY BACKUP.	LITHONIA	2GTL 2 33L GZ10 LP835 EL14L 3
С	ф	6" RECESSED LED DOWNLIGHT. 25W, 2476 LUMENS, 3500K CCT. 80 CRI. 0-10V DIMMING.	LITHONIA	LBR6 ALO2 SWW1 AR LSS MWD MVOLT UGZ 90CRI
CE	<b>*</b>	6" RECESSED LED DOWNLIGHT. 25W, 2476 LUMENS, 3500K CCT. 80 CRI. 0-10V DIMMING, PROVIDE 90 MIN BATTERY BACK-UP	LITHONIA	LBR6 ALO2 SWW1 AR LSS MWD MVOLT UGZ 90CRI
EX1	Ø	UNIVERSAL MOUNTING, SINGLE FACE, LED EMERGENCY EXIT SIGN WITH 90 MINUTE BATTERY BACKUP.	LITHONIA	LQM S W 3 R 120/277 EL N M6
EX2	<b>X</b>	UNIVERSAL MOUNTING, DOUBLE FACED EMERGENCY EXIT SIGN WITH 90 MINUTE BATTERY BACKUP.	LITHONIA	LQM S W 3 R 120/277 EL N M6
LE	1	MULLION MOUNTED LINEAR FIXTURE. 38.4W, 4264 LUMENS, 4000K CCT, 80 CRI. 90-MINUTE BATTERY BACKUP. WET LISTED. FINISH TBD BY ARCHITECT.	A-LIGHT	LIN 3 SP M8'LS 40 U HE M.5" XX D ES2 LT
S	•	1' X 4' SURFACE MOUNT LED FIXTURE. 21W, 2259 LUMENS, 3500K CCT. 80 CRI. 0-10V DIMMING	LITHONIA	TLX4 40L FW A12 EZ1 LP835 N80
SE		1' X 4' SURFACE MOUNT LED FIXTURE. 21W, 2259 LUMENS, 3500K CCT. 80 CRI. 0-10V DIMMING, PROVIDE 90 MIN BATTERY BACK-UP.	LITHONIA	TLX4 40L FW A12 EZ1 LP835 N80
V	1	2' WALL MOUNTED LED VANITY FIXTURE. 5W. 600 LUMENS, 3500K CCT. 80 CRI. WALL MOUNTED 0-10V DIMMING.	MARK LTG	S2WD LLP 2FT MSL2 80CRI 35K 300LMF SCT MIN10 FLL MVOLT WHTT ZT
W2	ф	EXTERIOR LED WALL PACK. 47W, 5896 LUMENS, 4000K CCT. WET LOCATION.	LITHONIA	WPX2 LED 40K MVOLT DBLXD
WE	<b>.</b>	SQUARE EXTERIOR WALL PACK. 36W, 5300 LUMENS, 4000K CCT, 80 CRI. 0-10V DIMMING, PROVIDE 90 MINUTE BATTERY BACKUP.	LITHONIA	TWR1 LED ALO SWW2 UVOLT PE DDBTXD

GENERAL NOTES:
EQUIVALENT ALTERNATE LIGHT FIXTURES MAY BE PROVIDED FOR BIDDING PURPOSES. THE ENGINEER DOES NOT TAKE RESPONSIBILITY FOR ENSURING ALTERNATE LIGHT FIXTURES USED FOR BIDDING ARE EQUAL; THE CONTRACTOR SHALL BE RESPONSIBLE FOR ENSURING ALTERNATE FIXTURES ARE EQUIVALENT TO THOSE SPECIFIED PRIOR TO BID. THE WINNING BID PACKAGE SHALL BE SUBMITTED TO THE ENGINEER FOR REVIEW IN ACCORDANCE WITH THE SPECIFICATIONS.

	ELECTRICAL A	BBR	EVIATIONS
AC	ABOVE COUNTERTOP	МС	MECHANICAL CONTRACTOR
AFF	ABOVE FINISH FLOOR	MCA	MINIMUM CIRCUIT AMPS
AFG	ABOVE FINISH GRADE	MDP	MAIN DISTRIBUTION PANEL
ANNC	ANNUNICIATOR	MTD	MOUNTED
CC	CONTROLS CONTRACTOR	NIC	NOT IN CONTRACT
DF	DRINKING FOUNTAIN	occ	OCCUPANCY
EC	ELECTRICAL CONTRACTOR	PC	PLUMBING CONTRACTOR
EF	EXHAUST FAN	PNL	PANEL
EX	EXISTING	SPST	SINGLE POLE SINGLE THROW
EXR	EXISTING RELOCATED	ТТВ	TELEPHONE TERMINAL BOARD
GC	GENERAL CONTRACTOR	TYP	TYPICAL
GFI	GROUND FAULT INTERRUPT	WG	WIRE GUARD
HP	HORSEPOWER	WP	WEATHER PROOF
IBC	INTERNATIONAL BUILDING CODE	20A	20 AMP
IG	ISOLATED GROUND	ø	PHASE
LV	LOW VOLTAGE	3W	3 WIRE
LVRP	LV RELAY PANEL	1P20A	SINGLE POLE 20 AMP

ELE	CTRICAL LEGEND
	PANEL BOARD
	DISTRIBUTION PANEL BOARD
T	TRANSFORMER
	UTILITY METER
CB	SEPARATE CIRCUIT BREAKER
	DISCONNECT
	FUSED DISCONNECT SWITCH
	EMERGENCY FUSED DISCONNECT SWITCH
$\boxtimes$	MOTOR STARTER/CONTRACTOR
$\boxtimes$ $\vdash$	COMBINATION MOTOR STARTER
H•	PUSH BUTTON STATION AS NOTED
Р	PULL BOX, SIZE AS REQUIRED BY CODE
lacktriangle	ELECTRICAL CONNECTION
<i>/</i>	MOTOR CONNECTION
<b>V</b>	HOME RUN TO PANEL BOARD

	SWITCH LEGEND
SYMBOL	DESCRIPTION
\$	20A, 120/277V SPST SWITCH
\$.	20A, 120/277V LETTER INDICATES GROUP
\$3	20A, 120/277V 3-WAY
\$4	20A, 120/277V 4-WAY
\$ <sub>D</sub>	DIMMER SWITCH
\$ĸ	KEY OPERATED SWITCH
\$ <sub>oc</sub>	OCCUPANCY SENSOR SWITCH

GENERAL NOTE: SEE SPECIFICATIONS FOR MANUFACTURERS

	RECEPTACLE SCHEDULE
SYMBOL	DESCRIPTION
φ	DUPLEX RECEPTACLE
Ø	20A, 120V, 2P, 3W GROUNDING DUPLEX RECEPTACLE  RECEPTACLE MTD. 6" ABOVE COUNTER OR HGT SHOWN
脚	GFCI RECEPTACLE, MTD. 6" ABOVE COUNTER OR HGT SHOWN
Ψ̈́	20A, 120V, 2P, 3W GROUNDING DUPLEX GFCI RECEPTACLE — WEATHER PROOF (IN USE COVER)
#	QUADPLEX RECEPTACLE

GENERAL NOTE: SEE SPECIFICATIONS FOR MANUFACTURERS

## GENERAL ELECTRICAL NOTES

- CONTRACTOR TO VERIFY EXISTING ELECTRICAL CONDITIONS AND NOTIFY ARCHITECT/ENGINEER OF ANY ELECTRICAL OR CODE ISSUES PRIOR TO BID. CONTRACTOR IS RESPONSIBLE FOR PROVIDING A COMPLETE AND OPERATIONAL CODE COMPLIANT SYSTEM.
- 2. ALL WORK SHALL BE IN CONFORMANCE WITH NATIONAL, STATE, AND LOCAL CODES AND/OR ORDINANCES.
- ELECTRICAL CONTRACTOR SHALL COORDINATE WORK WITH ALL OTHER CONTRACTORS & LOCAL UTILITY. E.C. SHALL CONTACT LOCAL UTILITY FOR EXACT SERVICE REQUIREMENTS TO INCLUDE BUT NOT LIMITED TO TRANSFORMER, METERING AND CABLING. LOCAL UTILITY REQUIREMENTS SUPERSEDE DRAWINGS AND SPECIFICATIONS.
- SEE TECHNOLOGY DRAWINGS FOR ADDITIONAL REQUIREMENTS.
- 5. ELECTRICAL DRAWINGS ARE DIAGRAMMATIC ONLY. THEY ARE INTENDED TO GIVE APPROXIMATE LOCATIONS AND OVERALL DESIGN INTENT. THE ELECTRICAL CONTRACTOR SHALL BE RESPONSIBLE FOR PRODUCTS, MATERIALS, AND ELECTRICAL METHODS WHICH HAVE NOT BEEN SHOWN OR INDICATED BUT ARE REQUIRED FOR A COMPLETE SYSTEM TO THE STANDARDS OF THE INDUSTRY.
- 6. INSTALL LIGHTING FIXTURES IN ACCORDANCE WITH MANUFACTURER'S RECOMMENDATIONS. PROVIDE SUPPORTING DEVICES FOR ADEQUATE SUPPORT OF FIXTURES FROM STRUCTURE.
- UPON COMPLETION OF THE ELECTRICAL WORK, THE INSTALLATION SHALL BE TESTED FOR CONTINUITY, GROUNDS, AND SHORT CIRCUITS. THE ELECTRICAL CONTRACTOR SHALL DEMONSTRATE PROPER PERFORMANCE OF ALL SYSTEMS. ALL DEFECTIVE WORK OR MATERIALS SHALL BE REPLACED OR REPAIRED AS NECESSARY AND RETESTED.
- ELECTRICAL RACEWAYS THAT PENETRATE FIRE RATED ASSEMBLIES SHALL BE SLEEVED AND SEALED AS PER THE LOCAL BUILDING CODE.

FIXTURE LINE	PHASE STYLES
LINE STYLE	DESCRIPTION
	EXISTING FIXTURES TO REMAIN
	NEW/REPLACEMENT FIXTURES

	ELECTRICAL SHEET INDEX
E000	ELECTRICAL TITLE SHEET
E001	ELECTRICAL SPECIFICATIONS
ED101	ELECTRICAL DEMOLITION PLAN
E100	ELECTRICAL SITE PLAN
E101	ELECTRICAL LIGHTING PLAN
E201	ELECTRICAL POWER PLAN
E202	ELECTRICAL ROOF PLAN
E401	ONE-LINE DIAGRAM
E501	ELECTRICAL DETAILS
E601	ELECTRICAL SCHEDULES



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RED OAK
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SECURITY UPGRADES


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E000



2600 Van Buren St., Suite 2635
Norman, OK 73072
Salas O'Brien Registration: CA# 7058
Expiration Date: 6/30/2023
Salas O'Brien Project Number: 2024-02321

OWNERSHIP USE OF DOCUMENTS:

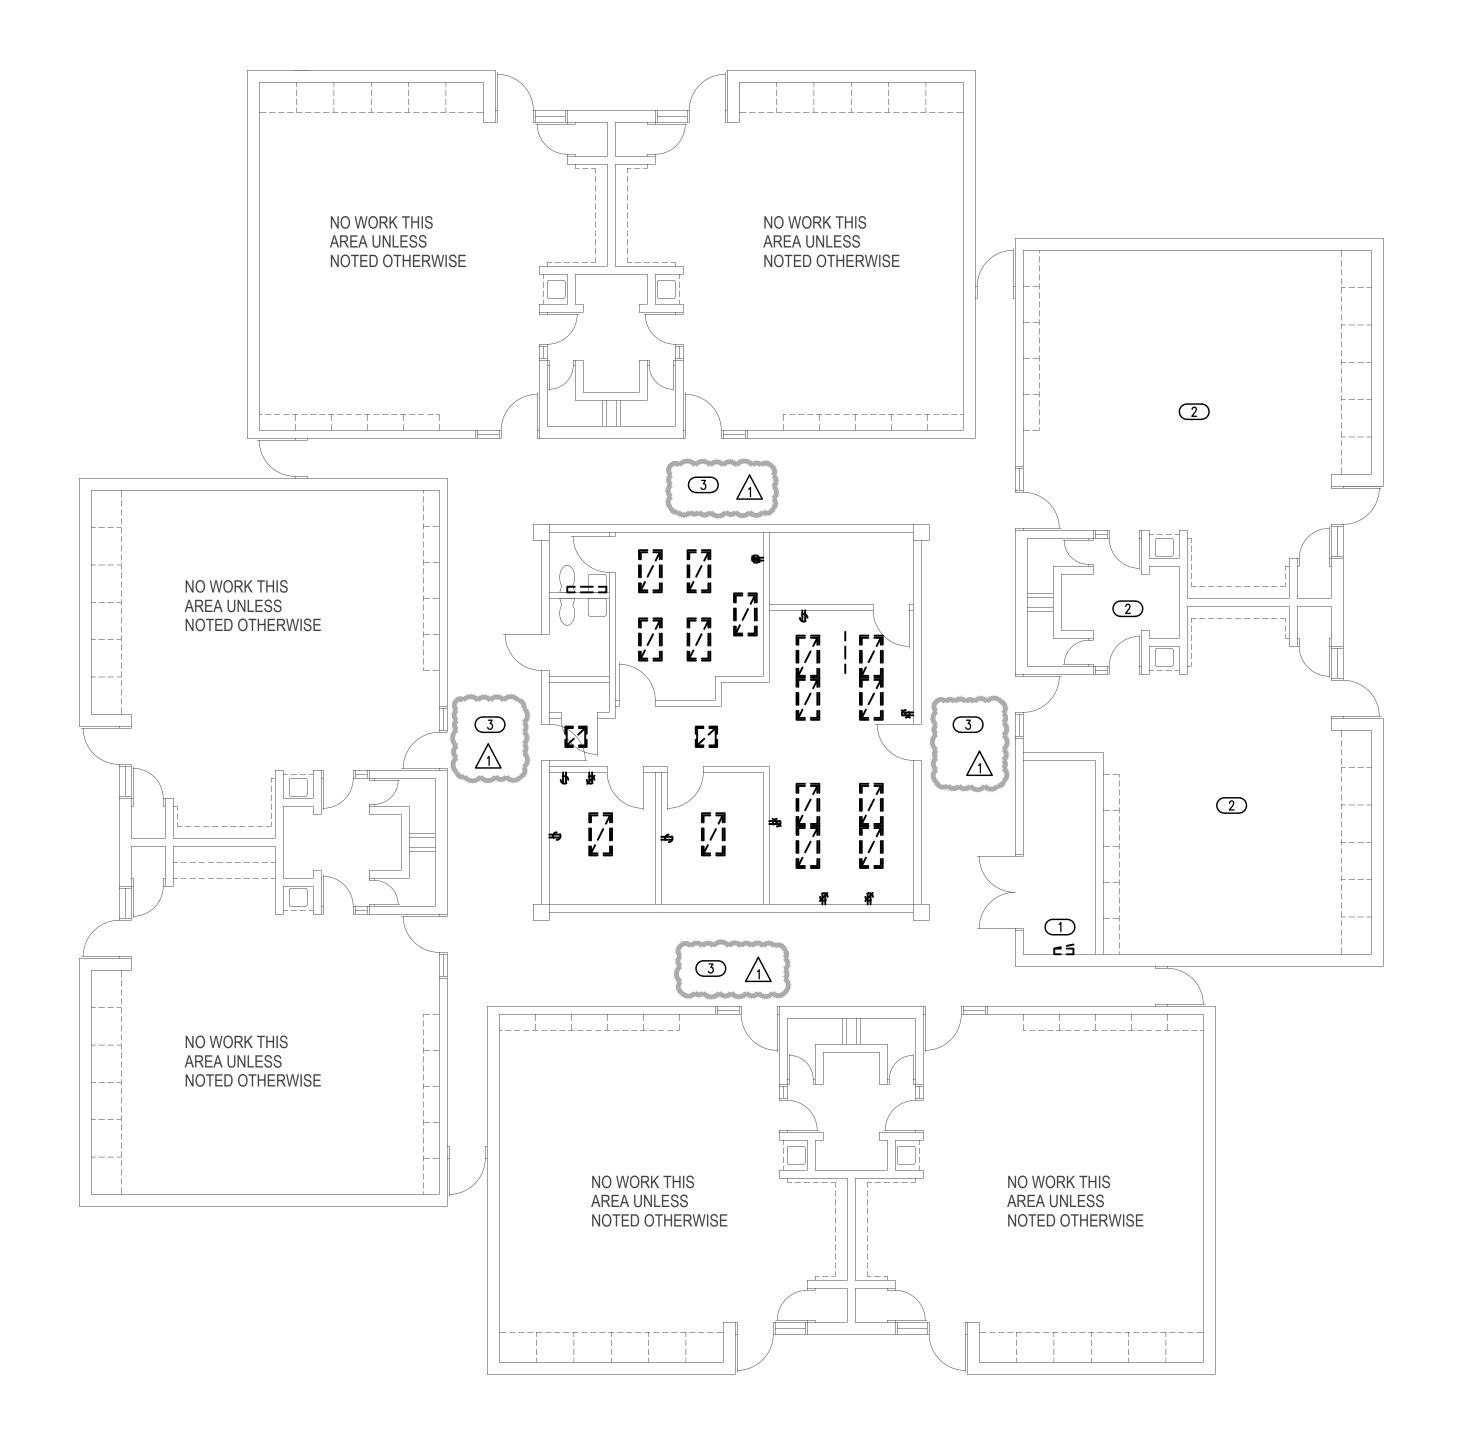

**1** ELECTRICAL DEMOLITION PLAN SCALE: 1/8" = 1'-0"



## **DEMOLITION GENERAL NOTES**

- 1. THESE DEMOLITION PLANS HAVE BEEN PREPARED TO ASSIST THE CONTRACTOR IN DETERMINING THE SCOPE OF DEMOLITION WORK TO BE INCLUDED IN THIS PROJECT. THE CONTRACTOR SHOULD REVIEW ALL DRAWINGS AND SPECIFICATIONS, INCLUDING DEMOLITION SHOWN FOR OTHER TRADES, AND BECOME FAMILIAR WITH THE EXISTING CONDITIONS, IN ORDER TO DETERMINE THE SCOPE OF DEMOLITION WORK.
- 2. ALL EXISTING LIGHT FIXTURES, SWITCHES, AND LIGHTING DEVICES ON DEMO SHEET SHALL BE REMOVED AND REPLACED WITH NEW FIXTURES AS INDICATED ON E000 AND E101.
- 3. ALL EXISTING RECEPTACLES AND OTHER DEVICES ON DEMO SHEET SHALL BE REMOVED AND REPLACED WITH NEW DEVICES AS INDICATED ON SHEET F201
- EXISTING CONDUIT AND WIRING MAYBE REUSED IF IN SERVICEABLE CONDITION, OTHERWISE PROVIDE NEW CONDUIT AND WIRE AS REQUIRED. NEW DEVICES AND FIXTURES SHALL BE CIRCUITED TO NEW PANELS AS INDICATED. EC SHALL FIELD VERIFY EXISTING CONDITIONS AND REPORT ANY ANOMALIES TO THE ARCHITECT AND ENGINEER PRIOR TO PROCEEDING.
- 5. DEMOLITION PLAN INFORMATION SHOWN AT TIME OF DESIGN. EC SHALL FIELD VERIFY EXISTING CONDITIONS AND MAKE ANY NECESSARY CHANGES TO COMPLETE THE WORK.
- 6. REMOVE ALL UNUSED WIRING AND CONDUIT AS PART OF THE DEMOLITION PROCESS.

# the Abla Griffin Partnership L.L.C.

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## DEMO KEYED NOTES

- 1 EC TO DEMOLISH EXISTING 400A PANEL AND FEEDERS 'D' AND REPLACE WITH NEW. REFER TO 'E201' AND 'E401' FOR ADDITIONAL INFORMATION.
- DEMOLISH ALL EXISTING LIGHT FIXTURES, SWITCHES AND RECEPTACLES IN AREA. ROOM WAS NOT ACCESSIBLE AT TIME OF DESIGN. EC TO FIELD VERIFY EXISTING CONDITIONS AND REPORT ANY ANOMALIES WITH ENGINEER PRIOR TO BEGINNING WORK.
- 3 DEMOLISH EXISTING LIGHT FIXTURES IN CORRIDORS AND REPLACE WITH NEW AS SHOWN ON E101. EC TO FIELD VERIFY EXISTING CONDITIONS AND REPORT ANY ANOMALIES WITH ENGINEER PRIOR TO BEGINNING WORK.



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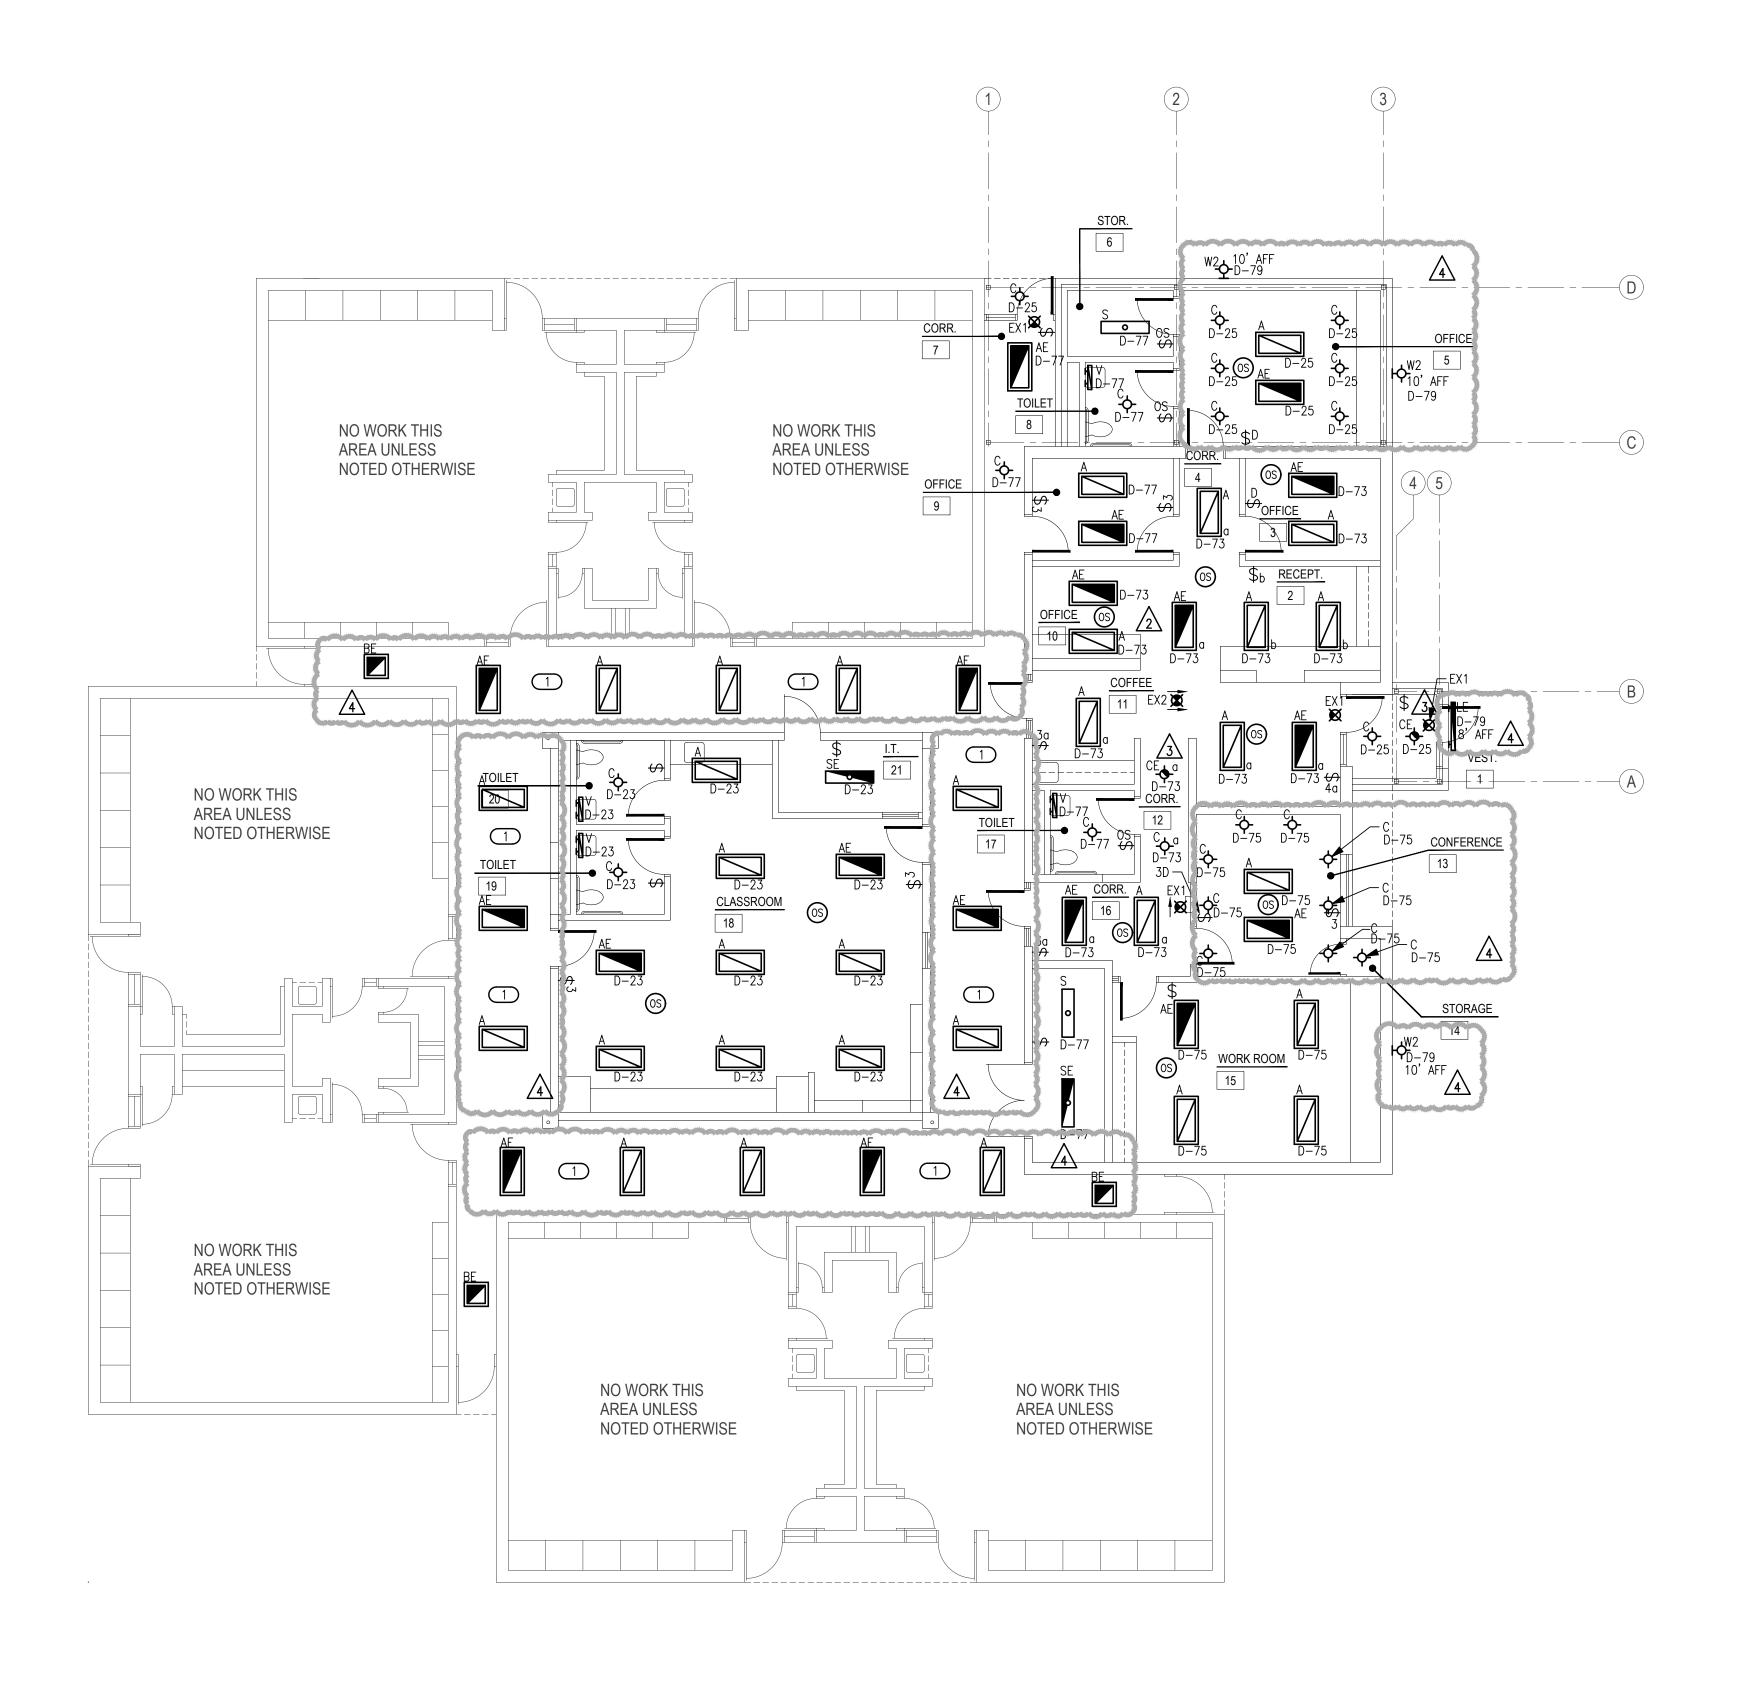
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SECURITY UPGRADES

sheet no:

ED101



2600 Van Buren St., Suite 2635 Norman, OK 73072 Salas O'Brien Registration: CA# 7058 Expiration Date : 6/30/2023 Salas O'Brien Project Number: 2024-02321 OWNERSHIP USE OF DOCUMENTS:



**1** ELECTRICAL LIGHTING PLAN SCALE: 1/8" = 1'-0"



## LIGHTING GENERAL NOTES

- OCCUPANCY SENSOR LOCATIONS SHOWN ARE FOR DESIGN INTENT ONLY.
  LOCATE OCCUPANCY SENSORS PER MANUFACTURER'S WRITTEN INSTALLATION INSTRUCTIONS.
- . CONNECT BATTERY PACKS TO UNSWITCHED HOT OF LOCAL LIGHTING CIRCUIT.
- 3. COORDINATE WITH ALL ASSOCIATED TRADES FOR THE EXACT LOCATIONS OF LIGHT FIXTURES WITH HVAC EQUIPMENT AND OTHER DEVICES/EQUIPMENT.
- 4. COORDINATE WITH THE ARCHITECT, OWNER, AND ASSOCIATED TRADES FOR THI EXACT HEIGHT/LOCATION OF EXTERIOR MOUNTED LIGHTING FIXTURES PRIOR TO ROUGH—IN.
- LABEL SWITCH PLATES AND J-BOXES WITH CIRCUIT PER SPECS.
- COORDINATE LIGHT SWITCHES WITH THERMOSTATS AND OTHER WALL MOUNT DEVICES

### **KEYED NOTES**

1 NEW LIGHT FIXTURES SHOWN IN CORRIDOR SHALL BE CONTROLED BY EXISTING SWITCHES AND POWERED FROM THEIR EXISTING BRANCH CIRCUITS. EC SHALL REUSE/EXTEND EXISTING CONDUIT AND WIRE TO FEED NEW FIXTURES AS NECESSARY FOR A COMPLETE CONNECTION.



the Abla Griffin Partnership L.L.C.

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12/16/24 CB-09

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RED OAK
ELEMENTARY SCHOOL
SECURITY UPGRADES

sheet no:

E101



Salas O'Brien Project Number: 2024-02321

1 FULL SHEET

Expiration Date: 6/30/2023

OWNERSHIP USE OF DOCUMENTS:

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			MEC	HANICAL	EQUIPME	NT SCHEDULE			
CALLOUT	DESCRIPTION	VOLTS	KVA	MCA	MOCP	WIRE CALLOUT	DISCONNECT	DISC PROV BY	DISC INST BY
AC-1	EXTERIOR MINI-SPLIT	208/120V 2P 3W	1.92	20	30	3/4"C,2#12,#12N,#12G	NON-FUSED	MC	EC
AC-1	INDOOR MINI-SPLIT	208/120V 2P 3W	3.33	20	30	3/4"C,2#10,#10N,#10G	NON-FUSED	MC	EC
AC-1	INDOOR MINI-SPLIT	208/120V 2P 3W	3.33	20	30	3/4"C,2#12,#12N,#12G	NON-FUSED	MC	EC
AC-1	EXTERIOR MINI-SPLIT	208/120V 2P 3W	1.92	20	30	3/4"C,2#12,#12N,#12G	NON-FUSED	MC	EC
AC-2	EXTERIOR MINI-SPLIT	208/120V 2P 3W	2.05	12.3	15	3/4"C,2#12,#12N,#12G	NON-FUSED	MC	EC
AC-2	INDOOR MINI-SPLIT	208/120V 2P 3W	2.05	12.3	15	3/4"C,2#10,#10N,#10G	NON-FUSED	MC	EC
AC-3	EXTERIOR MINI-SPLIT	208/120V 2P 3W	1.98	11.9	15	3/4"C,2#12,#12N,#12G	NON-FUSED	MC	EC
AC-3	INDOOR MINI-SPLIT	208/120V 2P 3W	1.98	11.9	15	3/4"C,2#12,#12N,#12G	NON-FUSED	MC	EC
AC-4	EXTERIOR MINI-SPLIT	208/120V 2P 3W	3.66	22	30	3/4"C,2#10,#10N,#10G	NON-FUSED	MC	EC
AC-4	INDOOR MINI-SPLIT	208/120V 2P 3W	3.66	22	30	3/4"C,2#10,#10N,#10G	NON-FUSED	MC	EC
CP-1	CIRCULATION PUMP	120V 1P 2W	0.24	2	15	3/4"C,1#10,#10N,#10G	HARDWIRED CONNECTION	EC	EC
EF-1	EXHAUST FAN	120V 1P 2W	0.7	7.25	15	3/4"C,1#12,#12N,#12G	TOGGLE SWITCH	EC	EC
EF-1	EXHAUST FAN	120V 1P 2W	0.7	7.25	15	3/4"C,1#12,#12N,#12G	TOGGLE SWITCH	EC	EC
EF-2	EXHAUST FAN	120V 1P 2W	0.15	2	15	3/4°C,1#12,#12N,#12G	TOGGLE SWITCH	EC	EC
EF-3	EXHAUST FAN	120V 1P 2W	0.15	2	15	3/4"C,1#12,#12N,#12G	TOGGLE SWITCH	EC	EC
EFH-1	ELECTRIC FAN FORCED HEATER	208/120V 2P 3W	1.5	9	15	3/4"C,2#10,#10N,#10G	NON-FUSED	MFR	EC
EWH-1	ELECTRIC WATER HEATER	208/120V 2P 3W	2.11	22	30	3/4"C,2#10,#10N,#10G	NON-FUSED	EC	EC

				MOUNTING FED FROM NOTE			BUS A NEUTR	RAL	600 100%			MAIN BKR LUGS STA	600 NDARD	
C #		CKT BKR	LOAD KVA	CIRCUIT	DESCRIPTI(	ON		CKT #	CKT BKR	LOAD KVA	CIRCL	JIT DESCRIP	TION	
	1	100/3	14	EXISTING	RTU LOAD		a	ł	100/3	14	EXIST	ING RTU LO	AD	
	- 1	100/3	14	FXISTING	RTU LOAD		b	İ						
					1110 2011		a	1 -	100/3	14	EXIST	ING LOAD		
(	- 1													
1		100/3	14	EXISTING	RTU LOAD		С	ł						
	3						a b	ł	20/1	0.2	1	ING LOAD ING LOAD		
		225/3	30	FXISTING	PANEL C		C	1	20/1 20/1	0.2	ł	ING LOAD		
				2,4011110	7,11,122		a	1	20/1	0.54	1	TS 19 AND	20	
2	1	j					b	22	20/1	0.54	1	SROOM 18		
/ 4 \		20/1	0.896	l l			c	ł	20/1	0.18		SROOM 18		
<u> </u>			ł	•			a	ł	20/1	0.18	TV	DN 45		
		•		ł			b	ł	20/1 20/1	0.18 0.54	ł	RM 15 IDOR 16		
		•	l l				a	t	20/1	0.54	ł	ERENCE 32		
	- 1	20/1	0.18				b	ł	30/2	2.11	EWH-			
	19		c	ł										
	- 1	•					a	ł	15/1	0.24	CP-1			
ł		•	i i				b	t	15/2	1.5	EFH-	1		
			1				c	t	  15/1	0.15	  EF-3			
		•	1				b	ł	15/1	0.846	EF-2			
4			0.18	IT RECEF	TACLES		c	48		0.18	FACP			
l l			ł	ł			a	1	20/1	0.18	ACP			
		30/2	1.92	AC-1			b	ł	20/1	0.18	1	CEPTACLE		
		15 /2	2.05	AC-2			c	1	20/1 20/1	0.18	1	CEPTACLE CEPTACLE		
			2.00	7.0 2			b	t	30/2	3.66	AC-4			
5	9	15/2	1.98	AC-3			c	ł						
/\							a	ł	30/2	3.33	AC-1			
		20/2	0	SPACE			b	ł	15 /0	0.05	1,000			
		30/2	1.92	AC-1					15/2	2.05	AC-2			
6			1.52				b	ł	15/2	1.98	AC-3			
$ \begin{array}{c} \frac{4}{1} \\ \frac{1}{1} $		20/1	0.36	ROOFTOP	RECEPTAC	CLES	С	1						
		20/1	0.96	LIGHTING			a	Į.	20/2	0	SPAC	E		
		20/1	1.22	LIGHTING			b	ł	70 /0	7 77	1			
the second second		20/1 20/1	0.704	LIGHTING	LIGHTING			1	30/2	3.33	AC-1			
/		20/1	10.141	ISPACE	LIGITIING		b	ł	30/2	3.66	AC-4			
8		20/1	0	SPACE			С	1						
				CONN KVA	CALC KVA	<u> </u>				CON	IN KVA	CALC KVA	_	
		HTING RGEST MOT	OR	5.01 14	6.26 3.5	(125%) (25%)		MOTO RECE COOL	PTACLES	31.4 38.3 70		31.4 24.2 70	(100%) (50%>10) (100%)	
									SE A SE B	HASE LOAD		135 376 A 97% 102% 101%	_	

the Abla Griffin Partnership L.L.C.

> 201 N. BROADWAY SUITE 210 MOORE, OK. 73160 405.735.3477 AGP@theAGP.net www.theAGP.net

STRUCTURAL

SALAS O'BRIEN
PLUMBING / MECHANICAL / ELECTRICAL




MOORE PUBLIC SCHOOLS BOARD OF EDUCATION MOORE, OKLAHOMA



RED OAK ELEMENTARY SCHOOL SECURITY UPGRADES

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E601

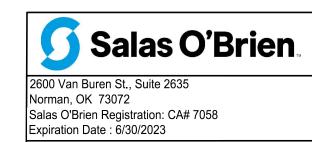

Salas O'Brien Project Number: 2024-02321

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