

- ALL WORK SHALL BE IN COMPLIANCE WITH STATE AND LOCAL CODES.
- THE CONTRACTOR SHALL PAY FOR ALL FEES, PERMITS, LICENSES, ETC., NECESSARY FOR PROPER COMPLETION OF THE WORK.
- . INSTALL ALL EQUIPMENT IN ACCORDANCE WITH MANUFACTURERS RECOMMENDATIONS.
- . VERIFY ALL EXISTING CONDITIONS. NOTIFY ENGINEER OF ANY CONFLICTS BETWEEN CONTRACT DRAWINGS AND ACTUAL CONDITIONS.
- OTHERWISE. . EXISTING UTILITIES TO BE ABANDONED SHALL BE PROPERLY DISCONNECTED AND CAPPED 17. PROVIDE VOLUME CONTROL DAMPERS WHERE INDICATED AND AT ALL TAKEOFFS, BOTH AS REQUIRED BY CODE OR LOCAL ORDINANCE. SUPPLY AND RETURN SYSTEMS, AND MAJOR DUCT RUNS. DAMPERS SHALL BE FACTORY-FABRICATED WITH ZINC-PLATED, DIE-CAST CONTROL HARDWARE. CONTROL THESE DRAWINGS ARE DIAGRAMMATIC AND SHALL NOT BE SCALED. ADDITIONAL DATA SHALL BE FROM THE ENGINEER THROUGH WRITTEN CLARIFICATION ONLY. VERIFY ALL EXISTING CONDITIONS, ELEVATIONS, AND DIMENSIONS BEFORE PROCEEDING WITH ANY PORTION OF ANY WORK. THE CONTRACTOR SHALL PROVIDE ALL OFFSETS AND HARDWARE SHALL INCLUDE HEAVY GAUGE DIAL AND HANDLE WITH ELEVATED PLATFORM FOR INSULATED DUCT MOUNTING.
- TRANSITIONS REQUIRED TO MEET EXISTING CONDITIONS. THE CONTRACTOR SHALL PERFORM WORK IN A SKILLED AND PROFESSIONAL MANNER.
- ALL CONTRACTORS ARE RESPONSIBLE TO FIELD COORDINATE WORK SCHEDULE WITH OWNER REPRESENTATIVE.
- . THE CONTRACTOR SHALL WORK AND COORDINATE WITH THE OTHER TRADES.
- 0. ALL EQUIPMENT SHALL BE NEW AND IN UNDAMAGED CONDITION. ANY EQUIPMENT FOUND 20. DIFFUSER PATTERN 4-WAY UNLESS OTHERWISE INDICATED. PROVIDE FIBERGLASS DUCT DEFECTIVE SHALL BE IMMEDIATELY REMOVED FROM THE PROJECT. INSULATION WITH VAPOR BARRIER AS SCHEDULED UNLESS NOTED OTHERWISE.
- EQUIPMENT REQUIRING SERVICE. MAJOR EQUIPMENT INCLUDES BUT IS NOT LIMITED TO COILS, FANS, AND CONTROL WIRING DIAGRAMS. EACH PIECE OF EQUIPMENT SHALL STATE THE CONTRACT DATE AND THE NAME, ADDRESS AND PHONE NUMBER FOR THE PRIME FOR SPARE PARTS. THE MANUALS SHALL CONTAIN MAINTENANCE INSTRUCTIONS REQUIRED FOR THE INSTALLED EQUIPMENT. MANUALS SHALL BE BOUND IN A THREE RING HARD WALK THROUGH OF THE PROJECT.
- 2. PROVIDE 8 HOURS OF OWNER TRAINING FOR THE INSTALLED EQUIPMENT. TRAINING SHALL

VERIFIED.


. CONTRACTOR SHALL SUBMIT A CERTIFIED REPORT INDICATING SYSTEM PERFORMANCE INCLUDING, BUT NOT LIMITED TO, VOLTAGE AND AMPERAGE MEASUREMENTS OF ALL EQUIPMENT GREATER THAN 1/3 H.P. AIR BALANCE MEASUREMENTS OF OUTSIDE AIR DELIVERY, AIR HANDLING UNIT SUPPLY, SUPPLY DIFFUSERS, EXHAUST AND RETURN CERTIFICATION SHALL BE AS FOLLOWS:

I (name) of (company) CERTIFY THAT ALL MEASUREMENTS, FIGURES AND STATEMENTS INDICATED IN THIS REPORT WERE TAKEN BY ME OR UNDER MY SUPERVISION AND ARE ACCURATE AS OF (date). DESIGN FLOWS WERE BASED UPON PLANS DATED (xx/xx/xx).

	ABBREVIA	TIONS	
ADDAIADJAIAFFAIAIAIAIAIAIAIALTAIAOAIAPPRXAIARCHAIBDDB/BLDGBIBTUHBFCCICDCICONDCICONDCICONTCICOPCIDETDIDIDIDIAORDNDIDWGDI	MP DDENDUM DJUSTABLE BOVE FINISH FLOOR IR HANDLER UNIT NALOG INPUT LTERNATE NALOG OUTPUT PPROXIMATE RCHITECT, ARCHITECTURAL ACK DRAFT DAMPER UILDING RITSH THERMAL UNT PER HOUR ENTER EILING DIFFUSER UBIC FEET PER MINUTE LEAN OUT ONDENSATE ONTINUOUS OEFFICIENT OF PERFORMANCE RY BULB ETAIL OOR GRILLE IGITAL INPUT IAMETER IMENSION OWN IGITAL OUTPUT RAWING	IN LAT LB LWT MAX MBH MCA MCA MECH MIN MFR NTS OA OC P PC PLBG PSI QTY RA REQD REV RG RPM RTU	INCH LEAVING AIR TEMPERATURE POUND LEAVING WATER TEMPERATURE MAXIMUM 1000 BTU PER HOUR MECHANICAL CONTRACTOR MINIMUM CIRCUIT AMPS MECHANICAL MINIMUM MANUFACTURER NOT TO SCALE OUTSIDE AIR ON CENTER PUMP PLUMBING CONTRACTOR PLUMBING ON CENTER PUMP PLUMBING CONTRACTOR PLUMBING POUNDS PER SQUARE INCH QUANTITY RETURN AIR REQUIRED REVERSE OR REVISION RETURN AIR GRILLE REVOLUTIONS PER MINUTE ROOF TOP UNIT
DIM DI DN DC DI DO DI DWG DI EAT EN EC EL EF EN EG ED ELEC EL	IMENSION OWN IGITAL OUTPUT	REQD REV RG RPM	Required Reverse or Revision Return Air Grille Revolutions PER Minute
ESP EX EWT EN EXIST EX FA FF FPM FE FT FC GA GJ GALV GJ GC GI	AITERINAL STATIC PRESSURE NTERING WATER TEMPERATURE XISTING RESH AIR EET PER MINUTE OOT (FEET) AUGE/GAGE ALVANIZED ENERAL CONTRACTOR ALLONS PER MINUTE	T&B TEMP TG TYP V VAR VEL VFD VTR W/	TEST AND BALANCE TEMPERATURE OR TEMPORARY TRANSFER GRILLE TYPICAL VOLT VARIABLE OR VARIES VELOCITY VARIABLE FREQUENCY DRIVE VENT THRU ROOF WITH
Horiz Ho Hp Ho Ht Hi	YPSUM ORIZONTAL ORSEPOWER EIGHT IPUT/OUTPUT	W/IN W/O WB WC WT	WITHIN WITH OUT WET BULB WATER COLUMN (INCHES OF) WEIGHT

## GENERAL MECHANICAL NOTES

- 14. DUCT MATERIAL SHALL BE GALVANIZED OR ALUMINUM CONSTRUCTION IN ACCORDANCE WITH SMACNA DUCT CONSTRUCTION STANDARD 2005 FOR THE PRESSURE AND SEAL CLASS LISTED IN DUCTWORK/INSULATION SCHEDULE.
- 15. DUCT SIZES LISTED ON PLANS ARE THE REQUIRED CLEAR INTERIOR DIMENSIONS. 16. SUPPLY AND RETURN BRANCH DUCTS MAY BE INSULATED FLEX DUCT IF THE RUN IS LESS THAN 5 FEET IN LENGTH. ANY LENGTHS OVER 5 FEET SHALL BE RIGID DUCTWORK, DUCT SHALL BE THE SAME SIZE AS THE LISTED DIFFUSER THROAT UNLESS NOTED
- PROVIDE TURNING VANES IN ALL RECTANGULAR ELBOWS CONFORMING TO SMACNA DUCT CONSTRUCTION STANDARD 2005 FIG. 4-2 TYPE RE-3 WITH STANDARD RADIUS. WHERE SPACE PERMITS, PROVIDE RADIUSED ELBOWS IN ACCORDANCE WITH FIGURES 4-2, TYPE
- 19. ALL RECTANGULAR MAIN TO RECTANGULAR BRANCH CONNECTIONS, BOTH CONVERGING AND DIVERGING CONFIGURATIONS, SHALL HAVE A 45 DEG. ENTRY TAP CONSTRUCTED IN ACCORDANCE WITH SMACNA DUCT CONSTRUCTION STANDARD 2005 FIG. 4-6.
- INSULATION WITH VAPOR BARRIER AS SCHEDULED UNLESS NOTED OTHERWISE. . PROVIDE 3 COPIES OF AN OPERATION AND MAINTENANCE MANUAL FOR ALL MAJOR 21. MECHANICAL CONTRACTOR TO REPAIR ANY DAMAGE DONE TO THE FIRE PROOFING WHILE INSTALLING THE MECHANICAL TRADES. SEAL ALL PENETRATIONS THROUGH RATED
- STRUCTURES WITH UL LISTED FIRE SEAL DESIGNED FOR THE SPECIFIED APPLICATION. CONTRACTOR, SUBCONTRACTOR PERFORMING THE INSTALLATION, AND THE LOCAL VENDOR 22. THE CONTRACTOR SHALL TAKE ALL PRECAUTIONARY MEASURES TO PROTECT THE PUBLIC AND ADJACENT PROPERTIES FROM DAMAGE THROUGHOUT CONSTRUCTION.
- COVER BINDER. 0 & M MANUALS SHALL BE SUBMITTED TO THE OWNER PRIOR TO FINAL 23. THE CONTRACTOR SHALL GUARANTEE ALL WORKMANSHIP AND MATERIALS FOR A PERIOD OF ONE (1) YEAR FROM THE DATE OF SUBSTANTIAL COMPLETION OR AS OTHERWISE REQUIRED IN THE SPECIFICATIONS.
- BE HELD ONLY AFTER ALL OF THE EQUIPMENT IS INSTALLED AND PROPER OPERATION IS 24. MECHANICAL CONTRACTOR TO INCLUDE THE TEST AND BALANCE, AND ANY PERMIT FEES IN THEIR BID. 25. MECHANICAL CONTRACTOR SHALL VERIFY ALL ROOFTOP EQUIPMENT WEIGHTS, SIZES,
- LOCATIONS AND OPENINGS REQUIRED AND SHALL COORDINATE ANY CHANGES WITH THE ARCHITECT. GRILLES. AIR BALANCE SHALL BE WITHIN 10% OF DESIGN CONDITIONS. THE REPORT 26. UPON PROJECT COMPLETION, RECORD (AS-BUILT) DRAWINGS SHALL BE PROVIDED BY
  - THE CONTRACTOR TO THE BUILDING OWNER. ALL CHANGES MADE TO EQUIPMENT, DUCTWORK, AND GENERAL DESIGN SHALL BE NOTED ON THE DRAWINGS. PROVIDE IN PDF FORMAT OR PRINTED SET AT THE OWNER'S REQUEST.

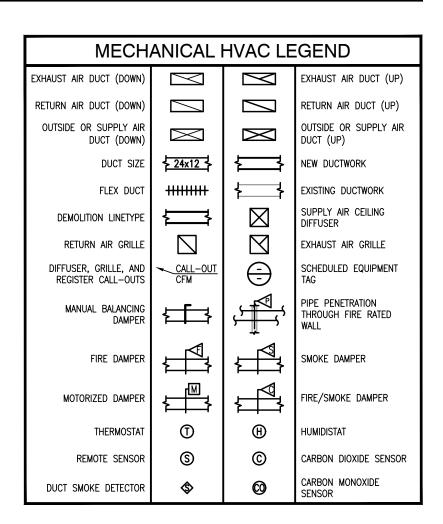

	MECHANICAL SHEET INDEX
мооо	MECHANICAL LEGEND AND NOTES
M101	MECHANICAL FLOORPLAN
M201	MECHANICAL ROOF PLAN
M501	MECHANICAL DETAILS
M601	MECHANICAL SCHEDULES



201 N. BROADWAY SUITE 210 MOORE, OK. 73160 405.735.3477 AGP@theAGP.net www.theAGP.net

KFC ENGINEERING

STRUCTURAL

SALAS O'BRIEN MECHANICAL / ELECTRICAL



KF	
drawn by	
DG	
checked by	
·	
OCTOBER 2024	
date	
revisions	



CHILD CARE FACILITY 201 N. EASTERN AVE.

sheet no:




OWNERSHIP USE OF DOCUMENTS:

AGP EXPRESSLY RESERVES ITS COPYRIGHT AND OTHER PROPERTY RIGHTS OF ALL PLANS AND DRAWINGS DESIGNED AND/OR PRODUCED. PLANS AND DRAWINGS ARE NOT TO BE REPRODUCED IN ANY FORM OR MANNER WITHOUT THE EXPRESSED WRITTEN CONSENT OF AGP.





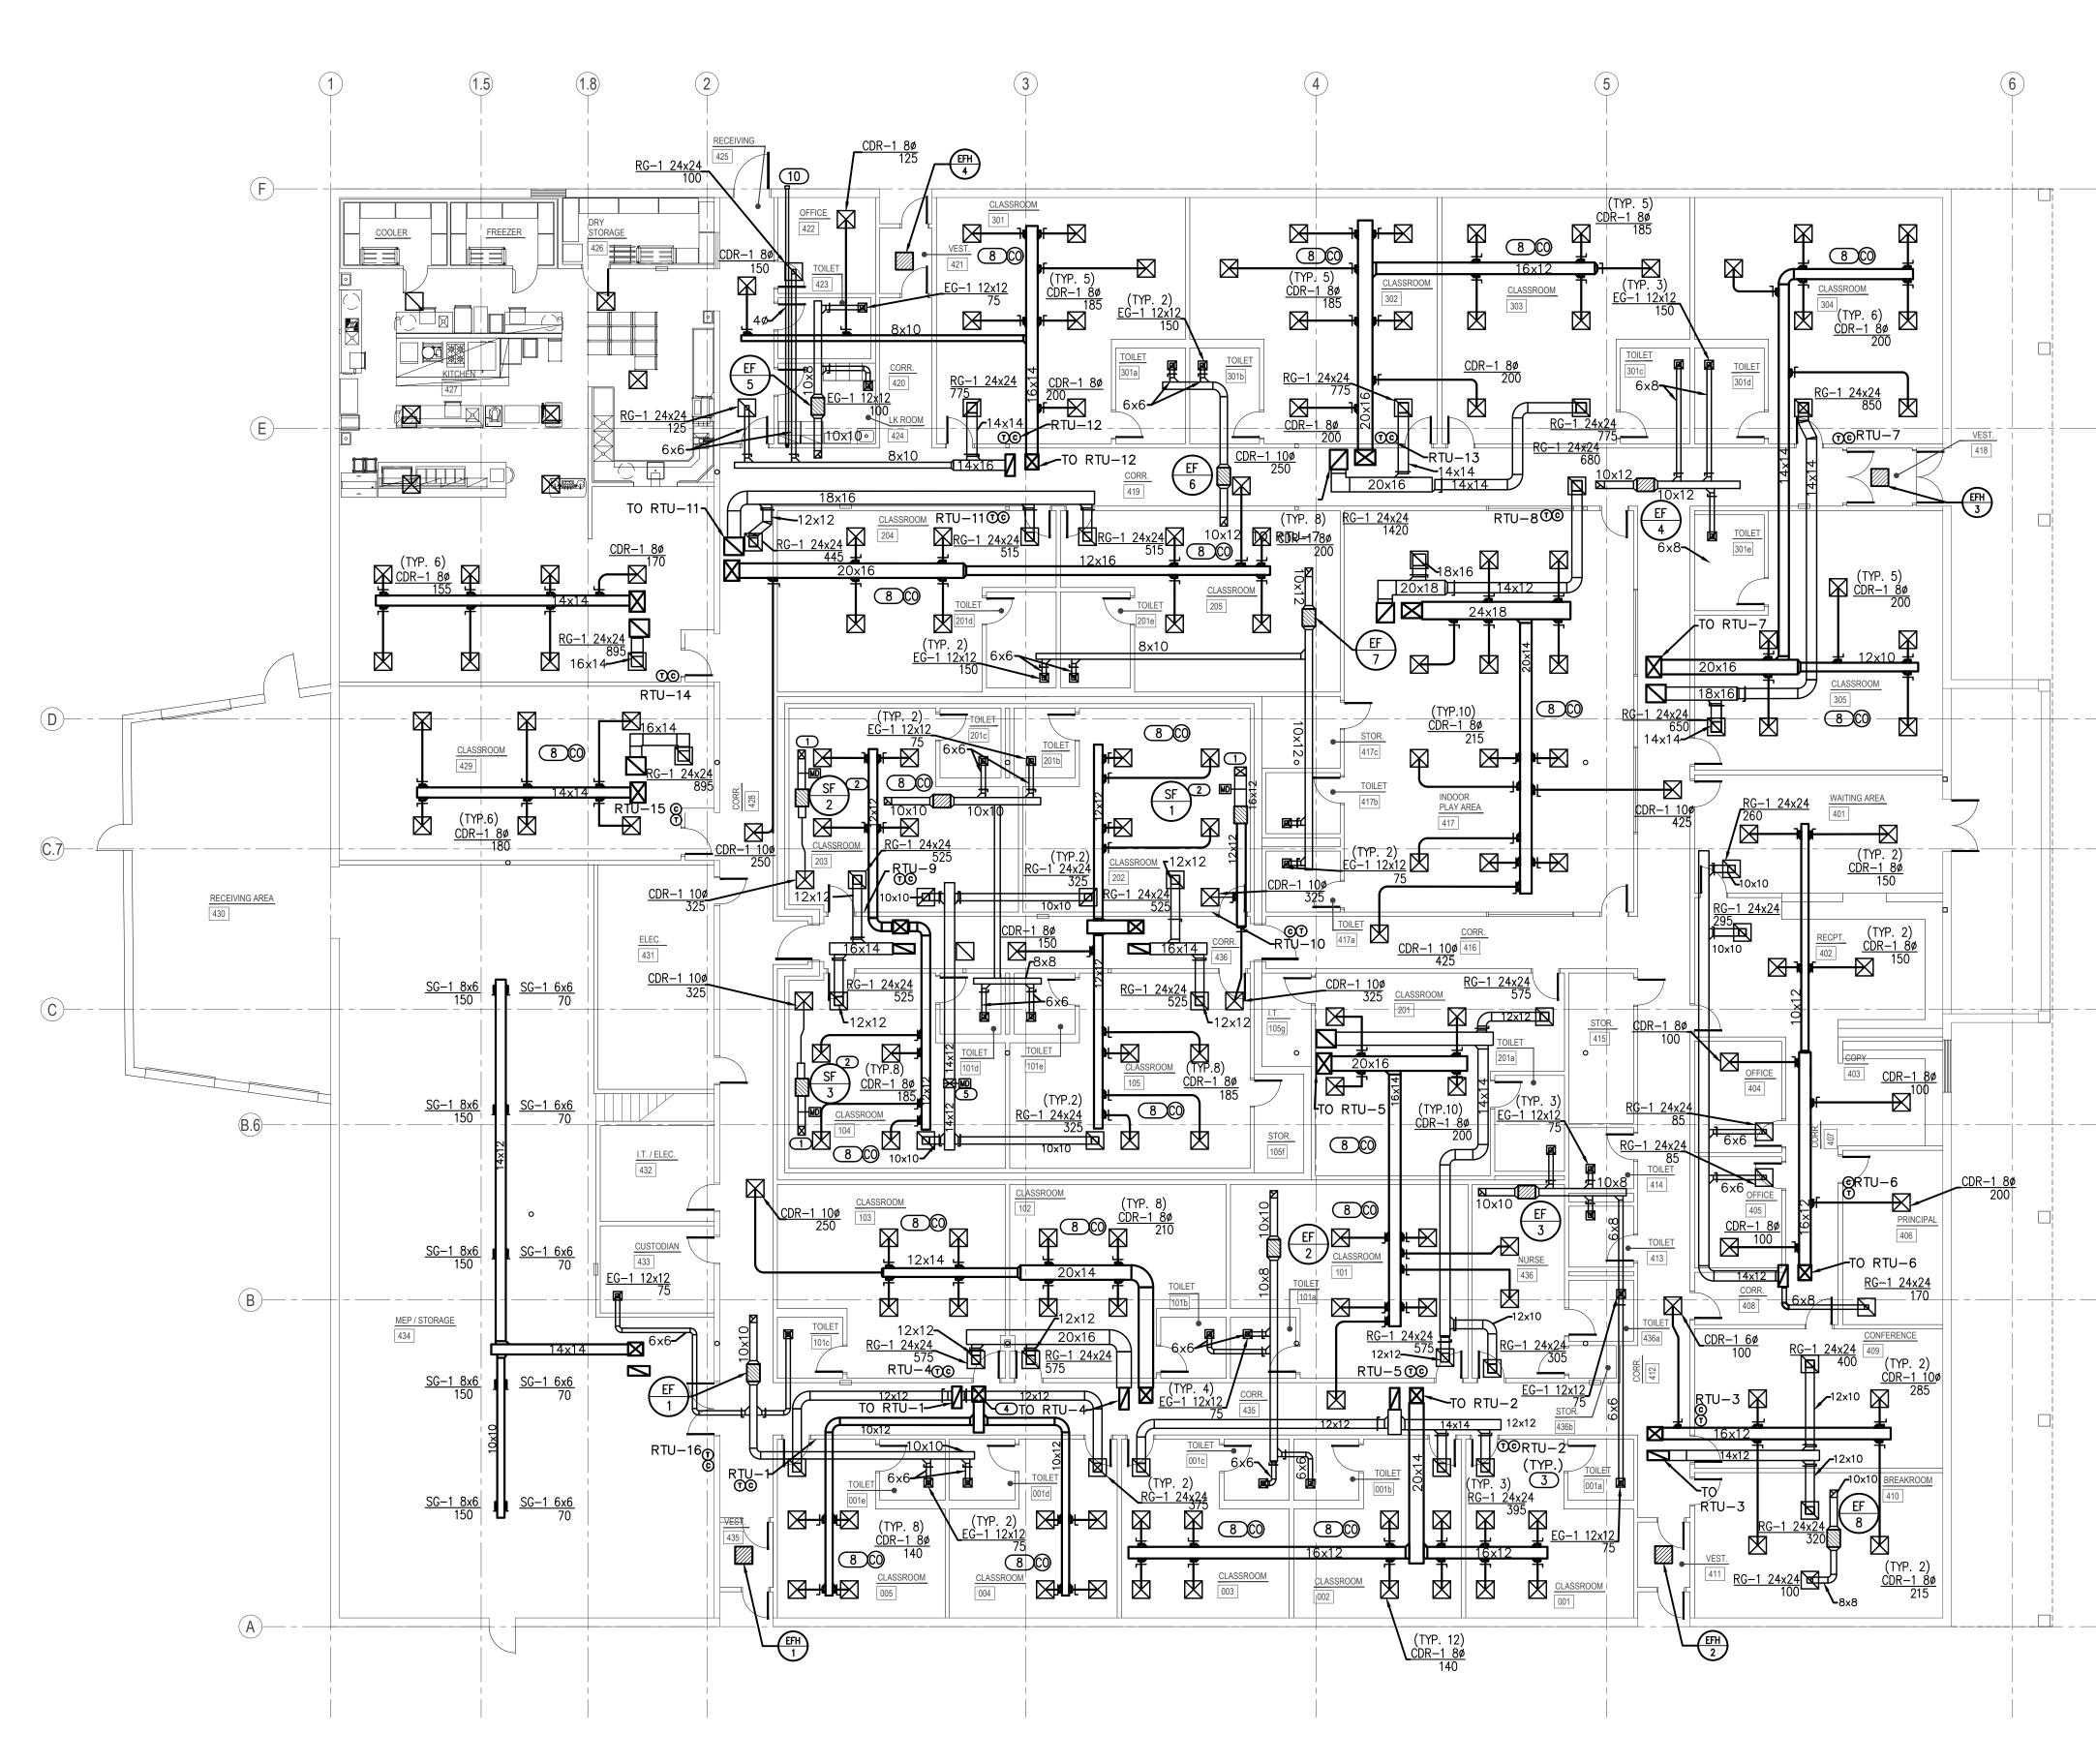


## GENERAL NOTES

- 1. COORDINATE INSTALLATION OF EQUIPMENT AND DUCTWORK WITH ALL TRADES.
- 2. COORDINATE LOCATION OF THERMOSTATS WITH E.C. ROUGH-IN BY E.C.
- 3. <u>ALL PENETRATIONS OVER 3 1/2 SQUARE INCHES OR 2 1/16 INCHES IN</u> <u>DIAMETER IN/OUT OF SHELTER REQUIRE SHROUD. REFER TO STRUCTURAL</u> <u>FOR ALL SHROUD DETAILS</u>.
- 4. <u>MC IS RESPONSIBLE TO ALL STRUCTURAL REQUIRED PENETRATION</u> <u>PROTECTION ITEMS FOR ALL MECHANICAL SYSTEMS PENETRATING THE</u> <u>SHELTER.</u>
- 5. E.C. TO PROVIDE, LOCATE, AND INSTALL SWITCH FOR EMERGENCY VENTILATION FAN. M.C. SHALL PROVIDE CALL OUT LETTERING "EMERGENCY VENTILATION" ON PLACARD ABOVE SWITCH WITH 3/4" LETTERING FOR INSTALLATION BY GC. COORDINATE WITH GC AND EC.

## **KEYED NOTES**

- 1 ROOF HOOD IS PART OF EMERGENCY VENTILATION SYSTEM. DUCT UP 16X12 TO TRANSITION INTO ROOF HOOD OPENING 18X16.
- 2 MOTORIZED DAMPER TO BE 120V CONNECTED TO EMERGENCY POWER. DAMPER SHALL OPEN WHEN SUPPLY FAN TURNS ON.
- 3 PROVIDE LOCKABLE COVER FOR THERMOSTAT.
- (4) DUCT 18X20 SUPPLY AND 12X28 RETURN UP TO RTU.
- 5 ROOF HOOD PART OF THE EMERGENCY VENTILATION SYSTEM TO PROVIDE RELIEF AIR. MOTORIZED DAMPER SHALL OPERATE ON INVERTER. INTERLOCK WITH SF-1. DUCT DOWN TO 16X12.
- 6 MOUNT BOTTOM OF LOUVER 8'-0" AFF.
- 7 MOUNT BOTTOM OF LOUVER MINIMUM 18" AFF.
- 8 CARBON MONOXIDE DETECTOR TO BE INSTALLED ACCORDING TO ALL APPLICABLE CODES. DETECTOR SHALL BE INSTALLED CENTRALLY ON CEILING. ALSO INCLUDE BATTERY BACKUP IN EVENT PRIMARY POWER IS INTERRUPTED. ALARM SIGNAL SHALL BE ROUTED TO ADMINISTRATION OFFICE. COORDINATE WITH E.C. WITH PRIMARY POWER CONNECTION AND SYSTEM CONNECTION.
- 9 PROVIDE EXHAUST DUCT TO GENERATOR RADIATOR CONNECTION. COORDINATE DUCT SIZE WITH GENERATOR MANUFACTURER DRAWINGS.
- 10 PROVIDE DRYER VENT EXHAUST HOOD TERMINATION AT EXTERIOR WALL IN ACCORDANCE WITH DRYER MANUFACTURER'S REQUIREMENTS. PROVIDE WALL CAP WITH BIRD FILTER.

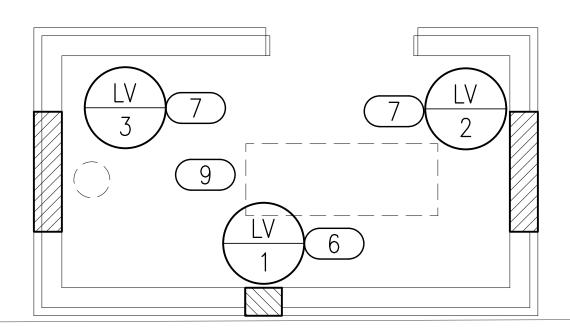

AGP
the Abla Griffin
Partnership L.L.C.

201 N. BROADWAY SUITE 210 MOORE, OK. 73160 405.735.3477 AGP@theAGP.net www.theAGP.net

KFC ENGINEERING

STRUCTURAL

SALAS O'BRIEN MECHANICAL / ELECTRICAL



KF
drawn by
DG
checked by
OCTOBER 2024
date
revisions



CHILD CARE FACILITY 201 N. EASTERN AVE.

sheet no:

# M101


OWNERSHIP USE OF DOCUMENTS:

AGP EXPRESSLY RESERVES ITS COPYRIGHT AND OTHER PROPERTY RIGHTS OF ALL PLANS AND DRAWINGS DESIGNED AND/OR PRODUCED. PLANS AND DRAWINGS ARE NOT TO BE REPRODUCED IN ANY FORM OR MANNER WITHOUT THE EXPRESSED WRITTEN CONSENT OF AGP.








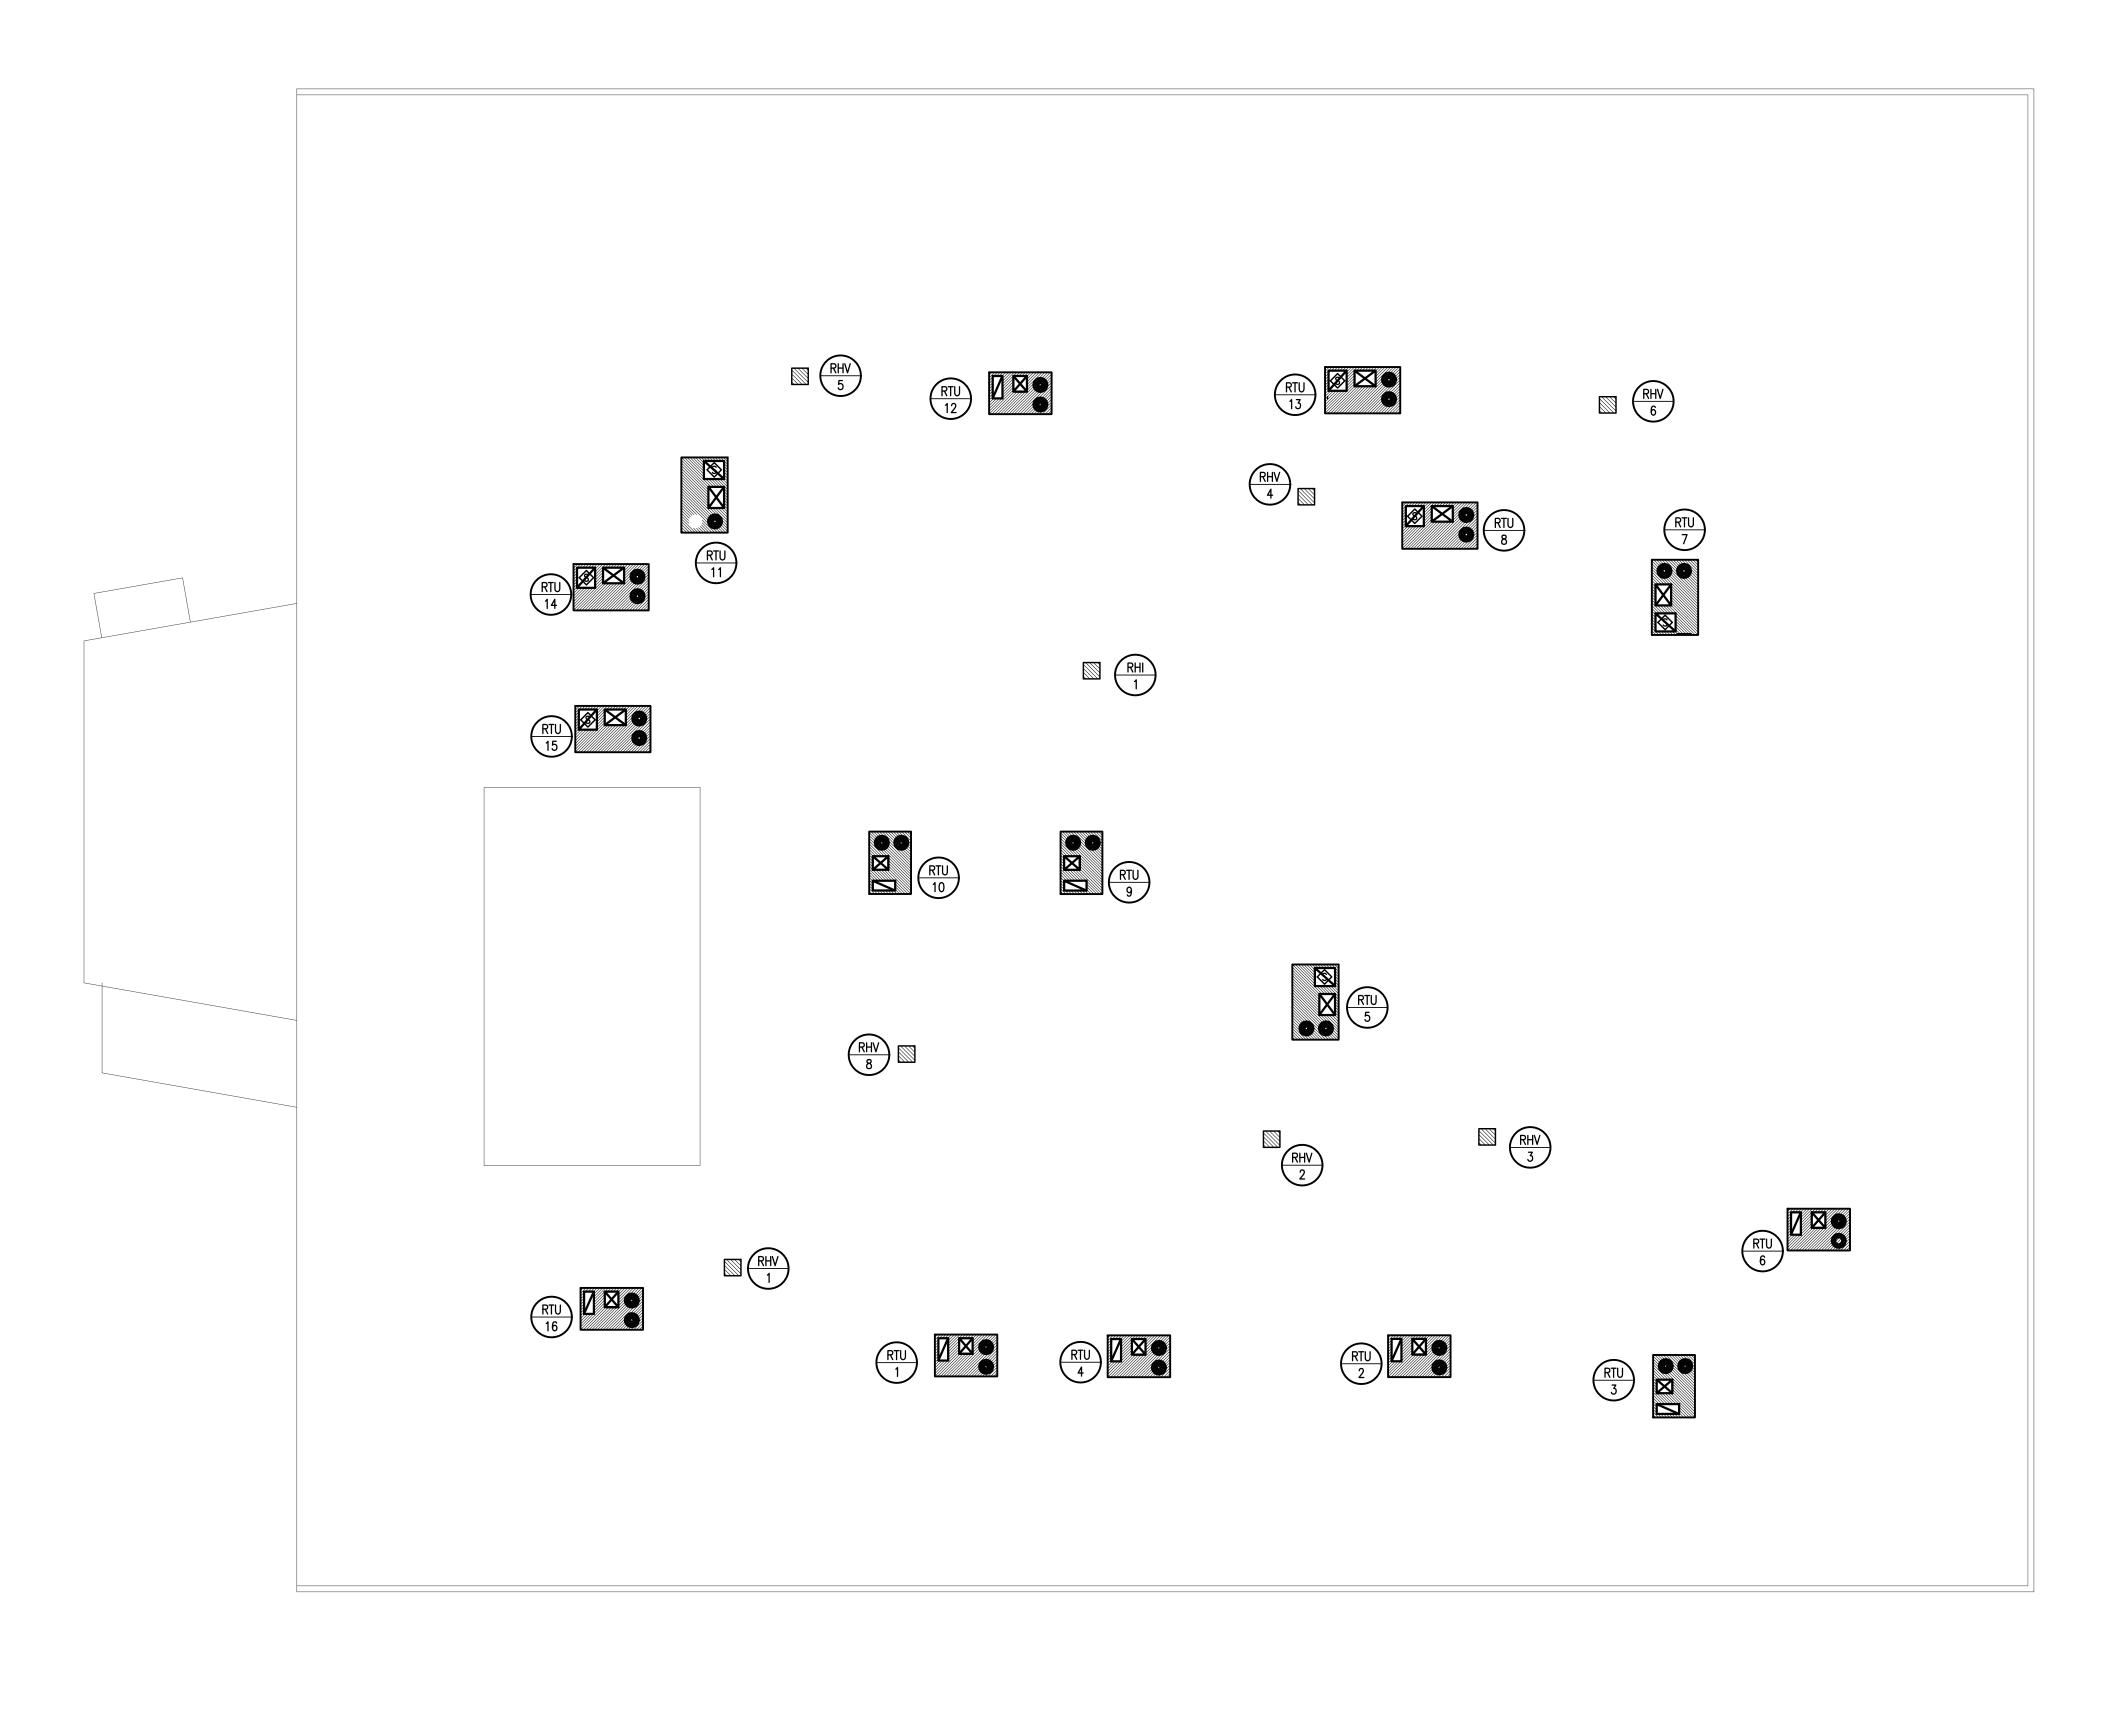

## **MECHANICAL ROOF PLAN** SCALE: 3/32" = 1'-0"

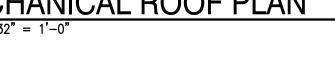

## GENERAL NOTES

- ALL ROOF TOP EQUIPMENT TO BE LOCATED A MINIMUM OF 10'-0" AWAY FROM ROOF EDGE.
- MAINTAIN A MINIMUM OF 10'—0" HORIZONTAL CLEARANCE BETWEEN ALL EXHAUST OUTLETS AND ANY FRESH AIR INTAKES.
- MOUNT ROOF CURBS LEVEL ON PITCHED ROOF.
- ALL ROOF SUPPORT SYSTEMS ARE TO BE MANUFACTURED FOR THE ROOF MATERIAL/SYSTEM TO BE INSTALLED. REFER TO ARCH PLANS FOR THE ROOF SYSTEM. CURB INSTALLATION TO BE WARRANTIED BY ROOFING CONTRACTOR.
- ALL PENETRATIONS OVER 3 1/2 SQUARE INCHES OR 2 1/16 INCHES IN DIAMETER IN/OUT OF THE SHELTER REQUIRE SHROUD. REFER TO STRUCTURAL FOR ALL SHROUD DETAILS.
- MC IS RESPONSIBLE FOR ALL STRUCTURAL REQUIRED PENETRATION PROTECTION ITEMS FOR ALL MECHANICAL SYSTEMS PENETRATING THE SHELTER.
- MC SHALL PROVIDE COPPER PIPING FOR CONDENSATE LINE PAINTED BLACK. ROUTE ALL CONDENSATE TO NEAREST ROOF DRAIN.



201 N. BROADWAY SUITE 210 MOORE, OK. 73160 405.735.3477 AGP@theAGP.net www.theAGP.net

KFC ENGINEERING

STRUCTURAL

SALAS O'BRIEN MECHANICAL / ELECTRICAL



KF drawn by

DG checked by

revisions

OCTOBER 2024 date



CHILD CARE FACILITY 201 N. EASTERN AVE.

sheet no:

M201


OWNERSHIP USE OF DOCUMENTS:

AGP EXPRESSLY RESERVES ITS COPYRIGHT AND OTHER PROPERTY RIGHTS OF ALL PLANS AND DRAWINGS DESIGNED AND/OR PRODUCED. PLANS AND DRAWINGS ARE NOT TO BE REPRODUCED IN ANY FORM OR MANNER WITHOUT THE EXPRESSED WRITTEN CONSENT OF AGP.








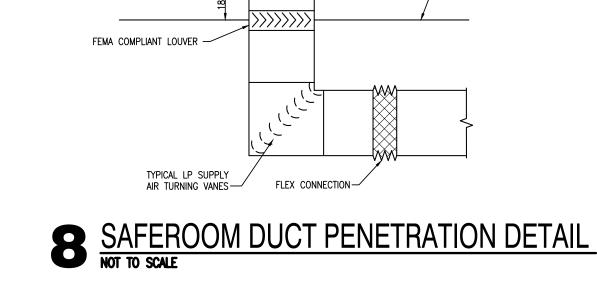

FLEX CONNECTION -

-DUCT TO ROOF EQUIPMENT

COUNTER

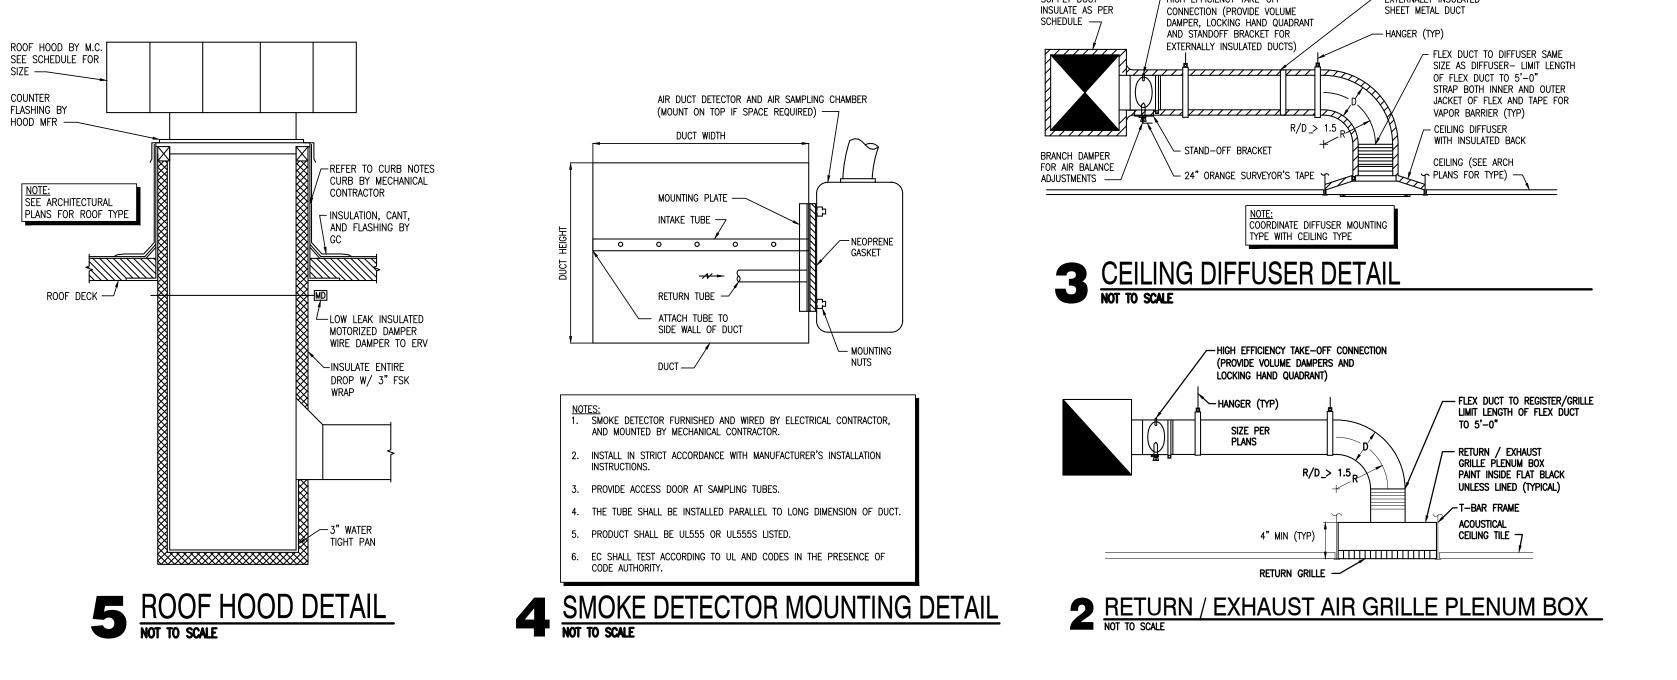


SUPPLY DUCT-


INSULATE AS PER

HIGH EFFICIENCY TAKE-OFF

-EXTERNALLY INSULATED

SHEET METAL DUCT

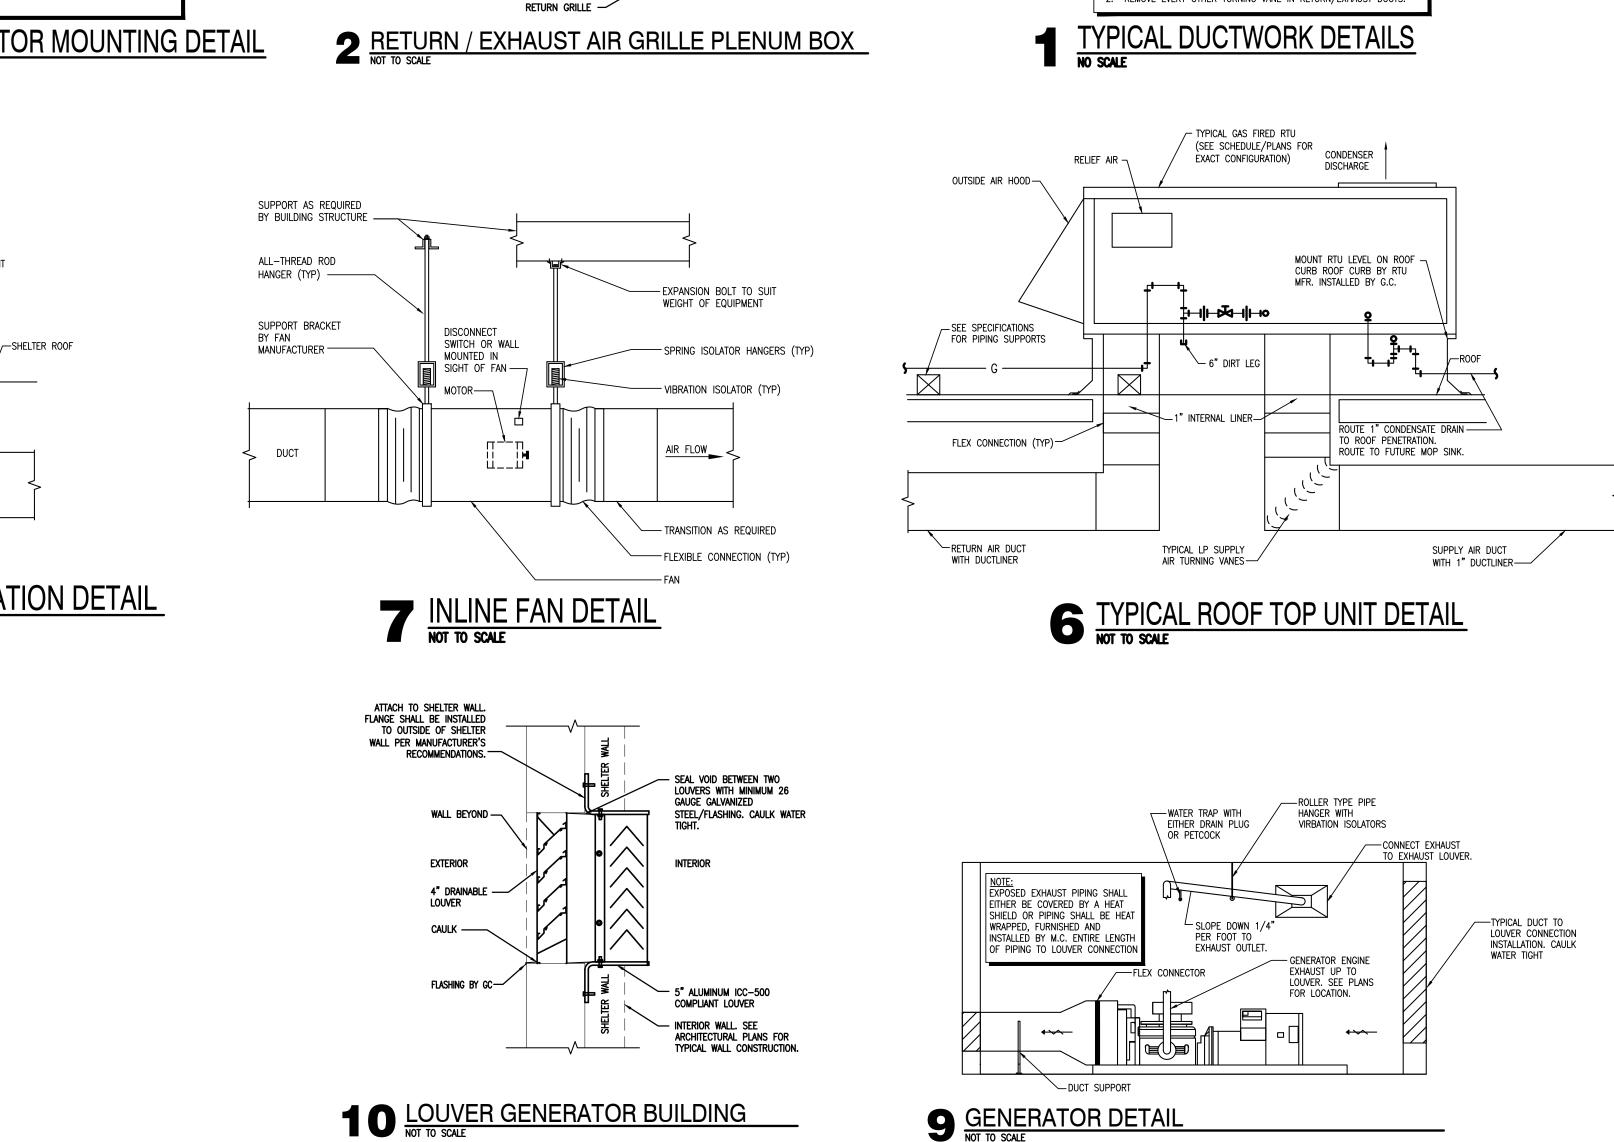

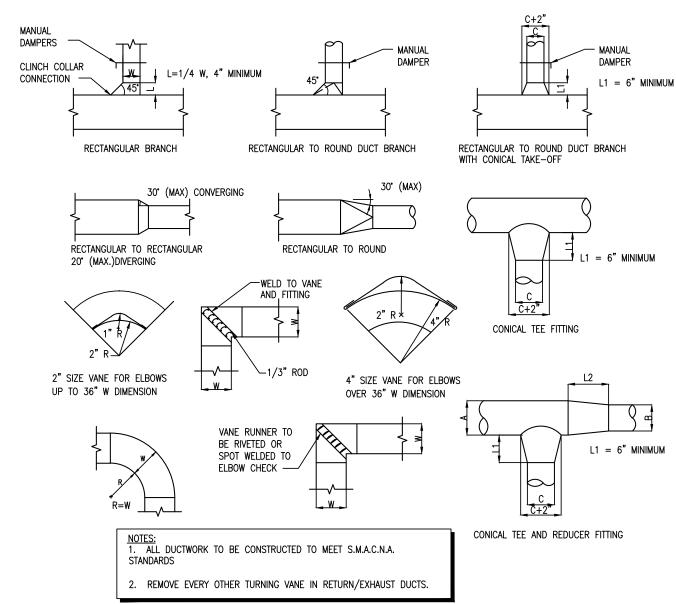



201 N. BROADWAY SUITE 210 MOORE, OK. 73160 405.735.3477 AGP@theAGP.net www.theAGP.net

KFC ENGINEERING STRUCTURAL

SALAS O'BRIEN

MECHANICAL / ELECTRICAL



KF	
drawn by	
DG	
checked by	
OCTOBER 2024	
date	
revisions	



CHILD CARE FACILITY 201 N. EASTERN AVE.


sheet no:

M501

OWNERSHIP USE OF DOCUMENTS:

AGP EXPRESSLY RESERVES ITS COPYRIGHT AND OTHER PROPERTY RIGHTS OF ALL PLANS AND DRAWINGS DESIGNED AND/OR PRODUCED. PLANS AND DRAWINGS ARE NOT TO BE REPRODUCED IN ANY FORM OR MANNER WITHOUT THE EXPRESSED WRITTEN CONSENT OF AGP.



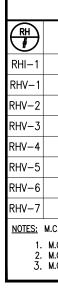

1	
2	
3	
NOTES:	M E
1. 2.	

	ROOF HOOD SCHEDULE												
	THROAT SIZE DIMENSION (IN)	THROAT AREA (FT <sup>2</sup> )	DAMPER BDD OR MOD	CONSTRUCTION	MANUFACTURER & MODEL NO.	COMMENTS	NOTES						
RHI-1	14X14	1.36	MOD	ALUMINUM	GREENHECK FGI	COLOR BY ARCHITECT	1-3						
RHV-1	10X10	0.69	MOD	ALUMINUM	GREENHECK FGI	COLOR BY ARCHITECT	1-3						
RHV-2	10X10	0.69	MOD	ALUMINUM	GREENHECK FGI	COLOR BY ARCHITECT	1-3						
RHV-3	10X10	0.69	MOD	ALUMINUM	GREENHECK FGI	COLOR BY ARCHITECT	1-3						
RHV-4	10X10	0.69	MOD	ALUMINUM	GREENHECK FGI	COLOR BY ARCHITECT	1-3						
RHV-5	10X10	0.69	MOD	ALUMINUM	GREENHECK FGI	COLOR BY ARCHITECT	1-3						
RHV-6	10X10	0.69	MOD	ALUMINUM	GREENHECK FGI	COLOR BY ARCHITECT	1–3						
RHV-7	14X14	1.36	MOD	ALUMINUM	GREENHECK FGI	COLOR BY ARCHITECT	1–3						
<u>NOTES:</u> M	I.C. IS RESPONSIBLE FOR PROVID	ING ANY AND ALL	NECESSARY DIME	NSIONAL, ELECTRICAL, MECHA	NICAL, AND STRUCTURAL ALTERATIONS NECESSITATED	BY PROVIDING ALTERNATE EQUIPMENT.							

1. M.C. TO PROVIDE ROOF HOOD WITH ALUMINUM BIRDSCREEN. 2. M.C. SHALL PROVIDE ROOF CURB. CURB INSTALLATION BY G.C. 3. M.C. SHALL PROVIDE LOW VOLTAGE MOTORIZED DAMPER.

	LOUVER SCHEDULE												
)	CONNECTED TO	SIZE (IN)	MINIMUM FREE AREA (FT²)	FLANGE	CONSTRUCTION	INCLUDE MOD	MANUFACTURER AND MODEL NUMBER	COMMENTS	NOTES				
	GEN ENCLOSURE	18X18	0.71	YES	ALUMINUM	-	GREENEHCK AFL-501	5" FEMA RATED LOUVER- PROVIDE ADDITIONAL DRAINABLE LOUVER ( GREENEHCK ESD-403)	1-2				
	GEN ENCLOSURE	60X72	14.98	YES	ALUMINUM	-	GREENEHCK AFL-501	5" FEMA RATED LOUVER- PROVIDE ADDITIONAL DRAINABLE LOUVER (GREENHECK ESD-403)	1-2				
	GEN ENCLOSURE	60X72	14.98	YES	ALUMINUM	-	GREENEHCK AFL-501	5" FEMA RATED LOUVÈR- PROVIDE ADDITIONAL DRAINABLE LOUVER (GREENHECK ESD-403)	1-2				
<u>:</u> 1.	M.C. IS RESPONSIBLE EQUIPMENT. PROVIDE PAINTED K PROVIDE BIRD SCRE	ynar finisi				ION, ELECTRI	ICAL, MECHANICAL, AND ST	RUCTURAL ALTERATIONS NECESSITATED BY PROVIDING ALTERNATE					

	PACKAGED ROOFTOP GAS/ELECTRIC UNIT SCHEDULE														
	LOCATION	input MBH	OUTPUT MBH	COOLING NOMINAL TONS	MIN EER	CAPACITY STAGES	TOTAL CFM	MIN F.A. CFM	ELEC CHAR	МСА	моср	ESP (IN)	WEIGHT	MANUFACTURER & MODEL NUMBER	NOTES
1	ROOF-SEE PLANS	65	52	3	14.3	2(H)/1(C)	1100	350	208 / 3	19	25	1.0	900	LENNOX LGM036U5E	1,2,4–12
2	ROOF-SEE PLANS	108	87	5	12.5	2(H)/1(C)	1680	520	208 / 3	26	40	1.0	905	LENNOX LGM060U5E	1,2,4–12
3	ROOF-SEE PLANS	65	52	3	14.3	2(H)/1(C)	1100	280	208 / 3	19	25	1.0	900	LENNOX LGM036U5E	1,2,4–12
4	ROOF-SEE PLANS	108	87	5	12.5	2(H)/1(C)	1700	535	208 / 3	26	40	1.0	905	LENNOX LGM060U5E	1,2,4–12
5	ROOF-SEE PLANS	180	144	7.5	12.5	2(H)/1(C)	2100	645	208 / 3	46	50	1.0	1500	LENNOX LGM092U5E	1-12
6	ROOF-SEE PLANS	65	52	3	14.3	2(H)/1(C)	1100	205	208 / 3	19	25	1.0	900	LENNOX LGM036U5E	1,2,4–12
7	ROOF-SEE PLANS	180	144	7.5	12.5	2(H)/1(C)	2200	700	208 / 3	46	50	1.0	1500	LENNOX LGM092U5E	1-12
8	ROOF-SEE PLANS	180	144	8.5	12.5	2(H)/1(C)	3000	900	208 / 3	48	50	1.0	1500	LENNOX LGM102U5E	1-12
9	ROOF-SEE PLANS	108	87	4	13.2	2(H)/1(C)	1500	450	208 / 3	25	35	1.0	905	LENNOX LGM048U5E	1,2,4–12
10	ROOF-SEE PLANS	108	87	5	12.5	2(H)/1(C)	1700	535	208 / 3	26	40	1.0	905	LENNOX LGM060U5E	1,2,4–12
11	ROOF-SEE PLANS	180	144	7.5	12.5	2(H)/1(C)	2100	625	208 / 3	46	50	1.0	1500	LENNOX LGM092U5E	1-12
12	ROOF-SEE PLANS	108	87	4	13.2	2(H)/1(C)	1400	400	208 / 3	25	35	1.0	905	LENNOX LGM048U5E	1,2,4–12
13	ROOF-SEE PLANS	180	144	7.5	12.5	2(H)/1(C)	2200	710	208 / 3	46	50	1.0	1500	LENNOX LGM092U5E	1-12
14	ROOF-SEE PLANS	65	52	3	14.3	2(H)/1(C)	1100	205	208 / 3	19	25	1.0	900	LENNOX LGM036U5E	1,2,4–12
15	ROOF-SEE PLANS	65	52	3	14.3	2(H)/1(C)	1100	205	208 / 3	19	25	1.0	900	LENNOX LGM036U5E	1,2,4–12
16	ROOF-SEE PLANS	65	52	3	14.3	2(H)/1(C)	1100	205	208 / 3	19	25	1.0	900	LENNOX LGM036U5E	1,2,4–12

NOTES: M.C. IS RESPONSIBLE FOR PROVIDING ANY AND ALL NECESSARY DIMENSIONAL, ELECTRICAL, MECHANICAL, AND STRUCTURAL ALTERATIONS NECESSARY BY PROVIDING ALTERNATE EQUIPMENT. EQUIPMENT.
PROVIDE CONDENSER COIL HAIL GUARD.
PROVIDE FACTORY-INSTALLED UNIT DISCONNECT SWITCH.
PROVIDE FACTORY-INSTALLED RETURN DUCT SMOKE DETECTOR WITH REMOTE TEST STATION AND CONNECTION TO FIRE ALARM SYSTEM BY E.C.
PROVIDE FACTORY-INSTALLED 120V GFCI CONVENIENCE OUTLET. GFCI POWERED FROM UNIT. RECEPTACLE SHALL BE COMPLIANT WITH NEC 210.63.
PROVIDE ANTI-SHORT CYCLE TIMER AND LOW AMBIENT CONTROLS.
PROVIDE AND TOUL-LESS ACCESS DOORS.
PROVIDE FACTORY ROOF CURB SO THAT THE BOTTOM OF THE ROOFTOP UNIT IS MINIMUM OF 14" ABOVE FINISHED ROOF. MOUNT LEVEL ON SLOPED ROOF.
PROVIDE FACTORY-INSTALLED UNIT DUCT SMOKE DETECTOR WITH REMOTE TEST STATION AND CONNECTION TO FIRE ALARM SYSTEM BY E.C.
PROVIDE FACTORY-INSTALLED 120V GFCI CONVENIENCE OUTLET. GFCI POWERED FROM UNIT. RECEPTACLE SHALL BE COMPLIANT WITH NEC 210.63.
PROVIDE ANTI-SHORT CYCLE TIMER AND LOW AMBIENT CONTROLS.

PLAN SYMBOL	DESCRIPTION	MANUFACTURER & MODEL NO.	MATERIAL	FINISH	NOISE CRITERIA
CDR-1	SQUARE FACE, ROUND NECK, 4–WAY DEFLECTION CEILING DIFFUSER, SPRING LOCK INNER CORE, FOR LAY–IN CEILING INSTALLATION.	PRICE SCD (4C)	STEEL	WHITE	-
SG-1	DOUBLE DEFLECTION SIDEWALL GRILLE, ADJUSTABLE DEFLECTION BLADES, 3/4" O.C. FLAT FRAME WITH 1 1/4" MARGIN, HORIZONTAL FRONT	PRICE 520	STEEL	COLOR BY ARCHITECT	-
RG-1	SQUARE PATTERN GRILLE, FIXED CORE OF 1/2"X1/2"X1/2" FABRICATED ALUMINUM SQUARES, FLAT FRAME WITH 1 1/4" MARGIN, FOR LAY-IN CEILING INSTALLATION.	PRICE 80	ALUMINUM	WHITE	-
RG-2	SQUARE PATTERN GRILLE, ZERO DEGREE DEFLECTION, FLAT STEEL FRAME WITH 1 1/4" BORDER, FOR SURFACE MOUNT INSTALLATION.	PRICE 80	STEEL	WHITE	-
EG-1	SQUARE PATTERN GRILLE, FIXED CORE OF 1/2"X1/2"X1/2" FABRICATED ALUMINUM SQUARES, FLAT FRAME WITH 1 1/4" MARGIN, FOR LAY-IN CEILING INSTALLATION.	PRICE 80	ALUMINUM	WHITE	-

DUCTWORK/INSULATION SCHEDULE													
		LOW PR	ESSURE		MED.	PRESS	HIGH F	PRESS.		INSULA	TION		
			SEAL		MAX		MAX		<u> </u>				
SYSTEM	MAX. PRES.	Α	В	С	PRES.	SEAL A	PRES.	SEAL A	INTERNAL	THICKNESS	EXTERNAL	THICKNESS	NOTES
SUPPLY AIR WITHIN 10' OF UNIT	2"	х	-	-	-	-	_	-	YES	1"	NO	-	-
SUPPLY AIR BEYOND 10' OF UNIT	2"	Х	-	-	-	-	-	-	NO	-	YES	2" FSK	-
RETURN AIR WITHIN 10' OF UNIT	2"	-	Х	-	-	-	-	-	YES	1"	NO	-	-
RETURN AIR BEYOND 10' OF UNIT	2"	-	Х	-	-	-	-	-	NO	-	YES	2" FSK	-
OUTSIDE AIR/MIXED AIR	2"	-	Х	-	-	-	-	-	NO	-	YES	3" FSK	-
EXHAUST AIR	2"	-	Х	-	-	-	-	-	NO	-	YES	2" FSK	-
NOTES:						••••••		••••••		1			

								FAN S	SCHEDUL	_E					
	CEM.	SP	FAN RPM	ELECTRICAL					DAMPER		FAN TYPE	INTERLOCK/	WEIGHT		NOTEC
	CFM			VOLTAGE & PHASE	H.P.	FLA/AMPS	MCA	MOCP	BDD OR MOD	DRIVE	FAN ITPE	CONTROL	WEIGHT	MANUFACTURER & MODEL NUMBER	NOTES
EF-1	225	0.5	1253	115/1	0.25	3.5	4	15	BOD	DIRECT	INLINE	SWITCH	50	GREENHECK SQ-98-VG	1,2,3
EF-2	300	0.5	1321	115/1	0.25	3.5	4	15	BOD	DIRECT	INLINE	SWITCH	50	GREENHECK SQ-98-VG	1,2,3
EF-3	375	0.5	1435	115/1	0.25	3.5	4	15	BOD	DIRECT	INLINE	SWITCH	50	GREENHECK SQ-98-VG	1,2,3
EF-4	450	0.5	1332	115/1	0.25	3.5	4	15	BOD	DIRECT	INLINE	SWITCH	50	GREENHECK SQ-99-VG	1,2,3
EF-5	300	0.5	1321	115/1	0.25	3.5	4	15	BOD	DIRECT	INLINE	SWITCH	50	GREENHECK SQ-98-VG	1,2,3
EF-6	175	0.5	1489	115/1	0.25	3.5	4	15	BOD	DIRECT	INLINE	SWITCH	50	GREENHECK SQ-97-VG	1,2,3
EF-7	300	0.5	1321	115/1	0.25	3.5	4	15	BOD	DIRECT	INLINE	SWITCH	50	GREENHECK SQ-98-VG	1,2,3
EF-8	100	0.3	1670	115/1	0.07	1.3	2	15	BOD	DIRECT	INLINE	SWITCH	30	GREENHECK SQ-60-VG	1,2,3
SF-1	750	0.5	1089	115/1	0.5	6.4	8	15	MOD	DIRECT	INLINE	SWITCH	65	GREENHECK SQ-120-VG	4-7
SF-2	325	0.5	1354	115/1	0.25	3.5	4	15	MOD	DIRECT	INLINE	SWITCH	50	GREENHECK SQ-98-VG	4-7
SF-3	325	0.5	1354	115/1	0.25	3.5	4	15	MOD	DIRECT	INLINE	SWITCH	50	GREENHECK SQ-98-VG	4-7

EQUIPMENT.

EQUIPMENT. 1. PROVIDE ELECTRONIC SPEED CONTROL MOUNTED ABOVE ACCESSIBLE CEILING. 2. M.C. SHALL PROVIDE AND INSTALL LOW VOLTAGE MOTORIZED DAMPER. 3. OPERATION OF DEVICE ON OCCUPIED MODE OF RTU OR SWITCH WITH LIGHTS. SEE INTERLOCK/CONTROL COLUMN FOR TYPE. 4. PROVIDE UNIT MOUNTED DISCONNECT. 5. FAN AND MOTORIZED DAMPER ARE PART OF EMERGENCY POWER SYSTEM. COORDINATE ALL CIRCUITS WITH EC. 6. ALL WIRING TO FAN AND DAMPER SHALL BE BY EC. 7. PROVIDE 120 V DAMPER.

				ELEC	CTRIC	FAN F	ORCE	D HEA	TER SO	CHEDI	JLE	
EFH #	ROOM NO.	CFM	WALL OR CEILING	ĸw	MOUNTING	ELECTRICAL CHAR	AMPS	SPEEDS	CONTROL	RPM	MANUFACTURER & MODEL NUMBER	NOTES
1	VEST	300	CEILING	2	RECESSED	208 / 1	9.6	1	INT STAT	1400	BERKO FFCH-548	1–3
2	VEST	300	CEILING	2	RECESSED	208 / 1	9.6	1	INT STAT	1400	BERKO FFCH-548	1-3
3	VEST	300	CEILING	2	RECESSED	208 / 1	9.6	1	INT STAT	1400	BERKO FFCH-548	1-3
4	VEST	300	CEILING	2	RECESSED	208 / 1	9.6	1	INT STAT	1400	BERKO FFCH-548	1–3
NUTES:	EQUIPMENT. PROVIDE INT	ERNAL THER	MOSTAT. IT. PROVIDE I			DIMENSIONA	L, ELECTRICA	L, MECHANICA	AL, AND STRU	CTURAL ALTE	RATIONS NECESSITATED BY PROVIDING ALTERN	ÂTE



201 N. BROADWAY SUITE 210 MOORE, OK. 73160 405.735.3477 AGP@theAGP.net www.theAGP.net

KFC ENGINEERING

STRUCTURAL

SALAS O'BRIEN MECHANICAL / ELECTRICAL



	KF
	drawn by
	DG
	checked by
_	OCTOBER 2024
	date
	revisions
-	
-	



CHILD CARE FACILITY 201 N. EASTERN AVE.

sheet no:

# M601

OWNERSHIP USE OF DOCUMENTS:

AGP EXPRESSLY RESERVES ITS COPYRIGHT AND OTHER PROPERTY RIGHTS OF ALL PLANS AND DRAWINGS DESIGNED AND/OR PRODUCED. PLANS AND DRAWINGS ARE NOT TO BE REPRODUCED IN ANY FORM OR MANNER WITHOUT THE EXPRESSED WRITTEN CONSENT OF AGP.

