# MOORE PUBLIC SCHOOLS - MOORE WEST JUNIOR HIGH SCHOOL - STEM ADDITION

Moore Public Schools - Moore, Oklahoma AGP - Moore, Oklahoma

#### **CONSTRUCTION BULLETIN NO. 1**

September 6, 2022

1. REVISE LOCATION OF NEW NATURAL GAS SERVICE AS PER ATTACHED DRAWINGS.

END OF CONSTRUCTION BULLETIN NO. 1



#### **CONSTRUCTION BULLETIN # 01**

Client: Abla Griffin Partnership

Project Name: Moore West JH Classroom Addition

Project Number: 2021-02932-00

September 6, 2022

Requested by: \_\_\_ Owner

X Contractor:

\_\_\_ Salas O'Brien: Enter Name Here

To: Mike Alba, Clay Griffin, AGP



This Construction Bulletin is issued to:

<u>_X</u> _	Offer additional	information	for c	clarification	or supp	lemental	drawings t	for l	layout
	assistance.								

Request cost and time impact to initiate a change to the Contract Documents. Owner
approval is required, do not commence with revisions unless directed in writing. Avoid
Work in areas that may be affected by proposed change until approved or rejected.
Once approved, forward Change Order documentation as required by the Contract
Documents.

Direct a required change in the Contract Documents. Proceed with change(s) as
indicated. Forward Change Order documentation as required by the Contract
Documents.

 Res	ponse	to	RFI	 •

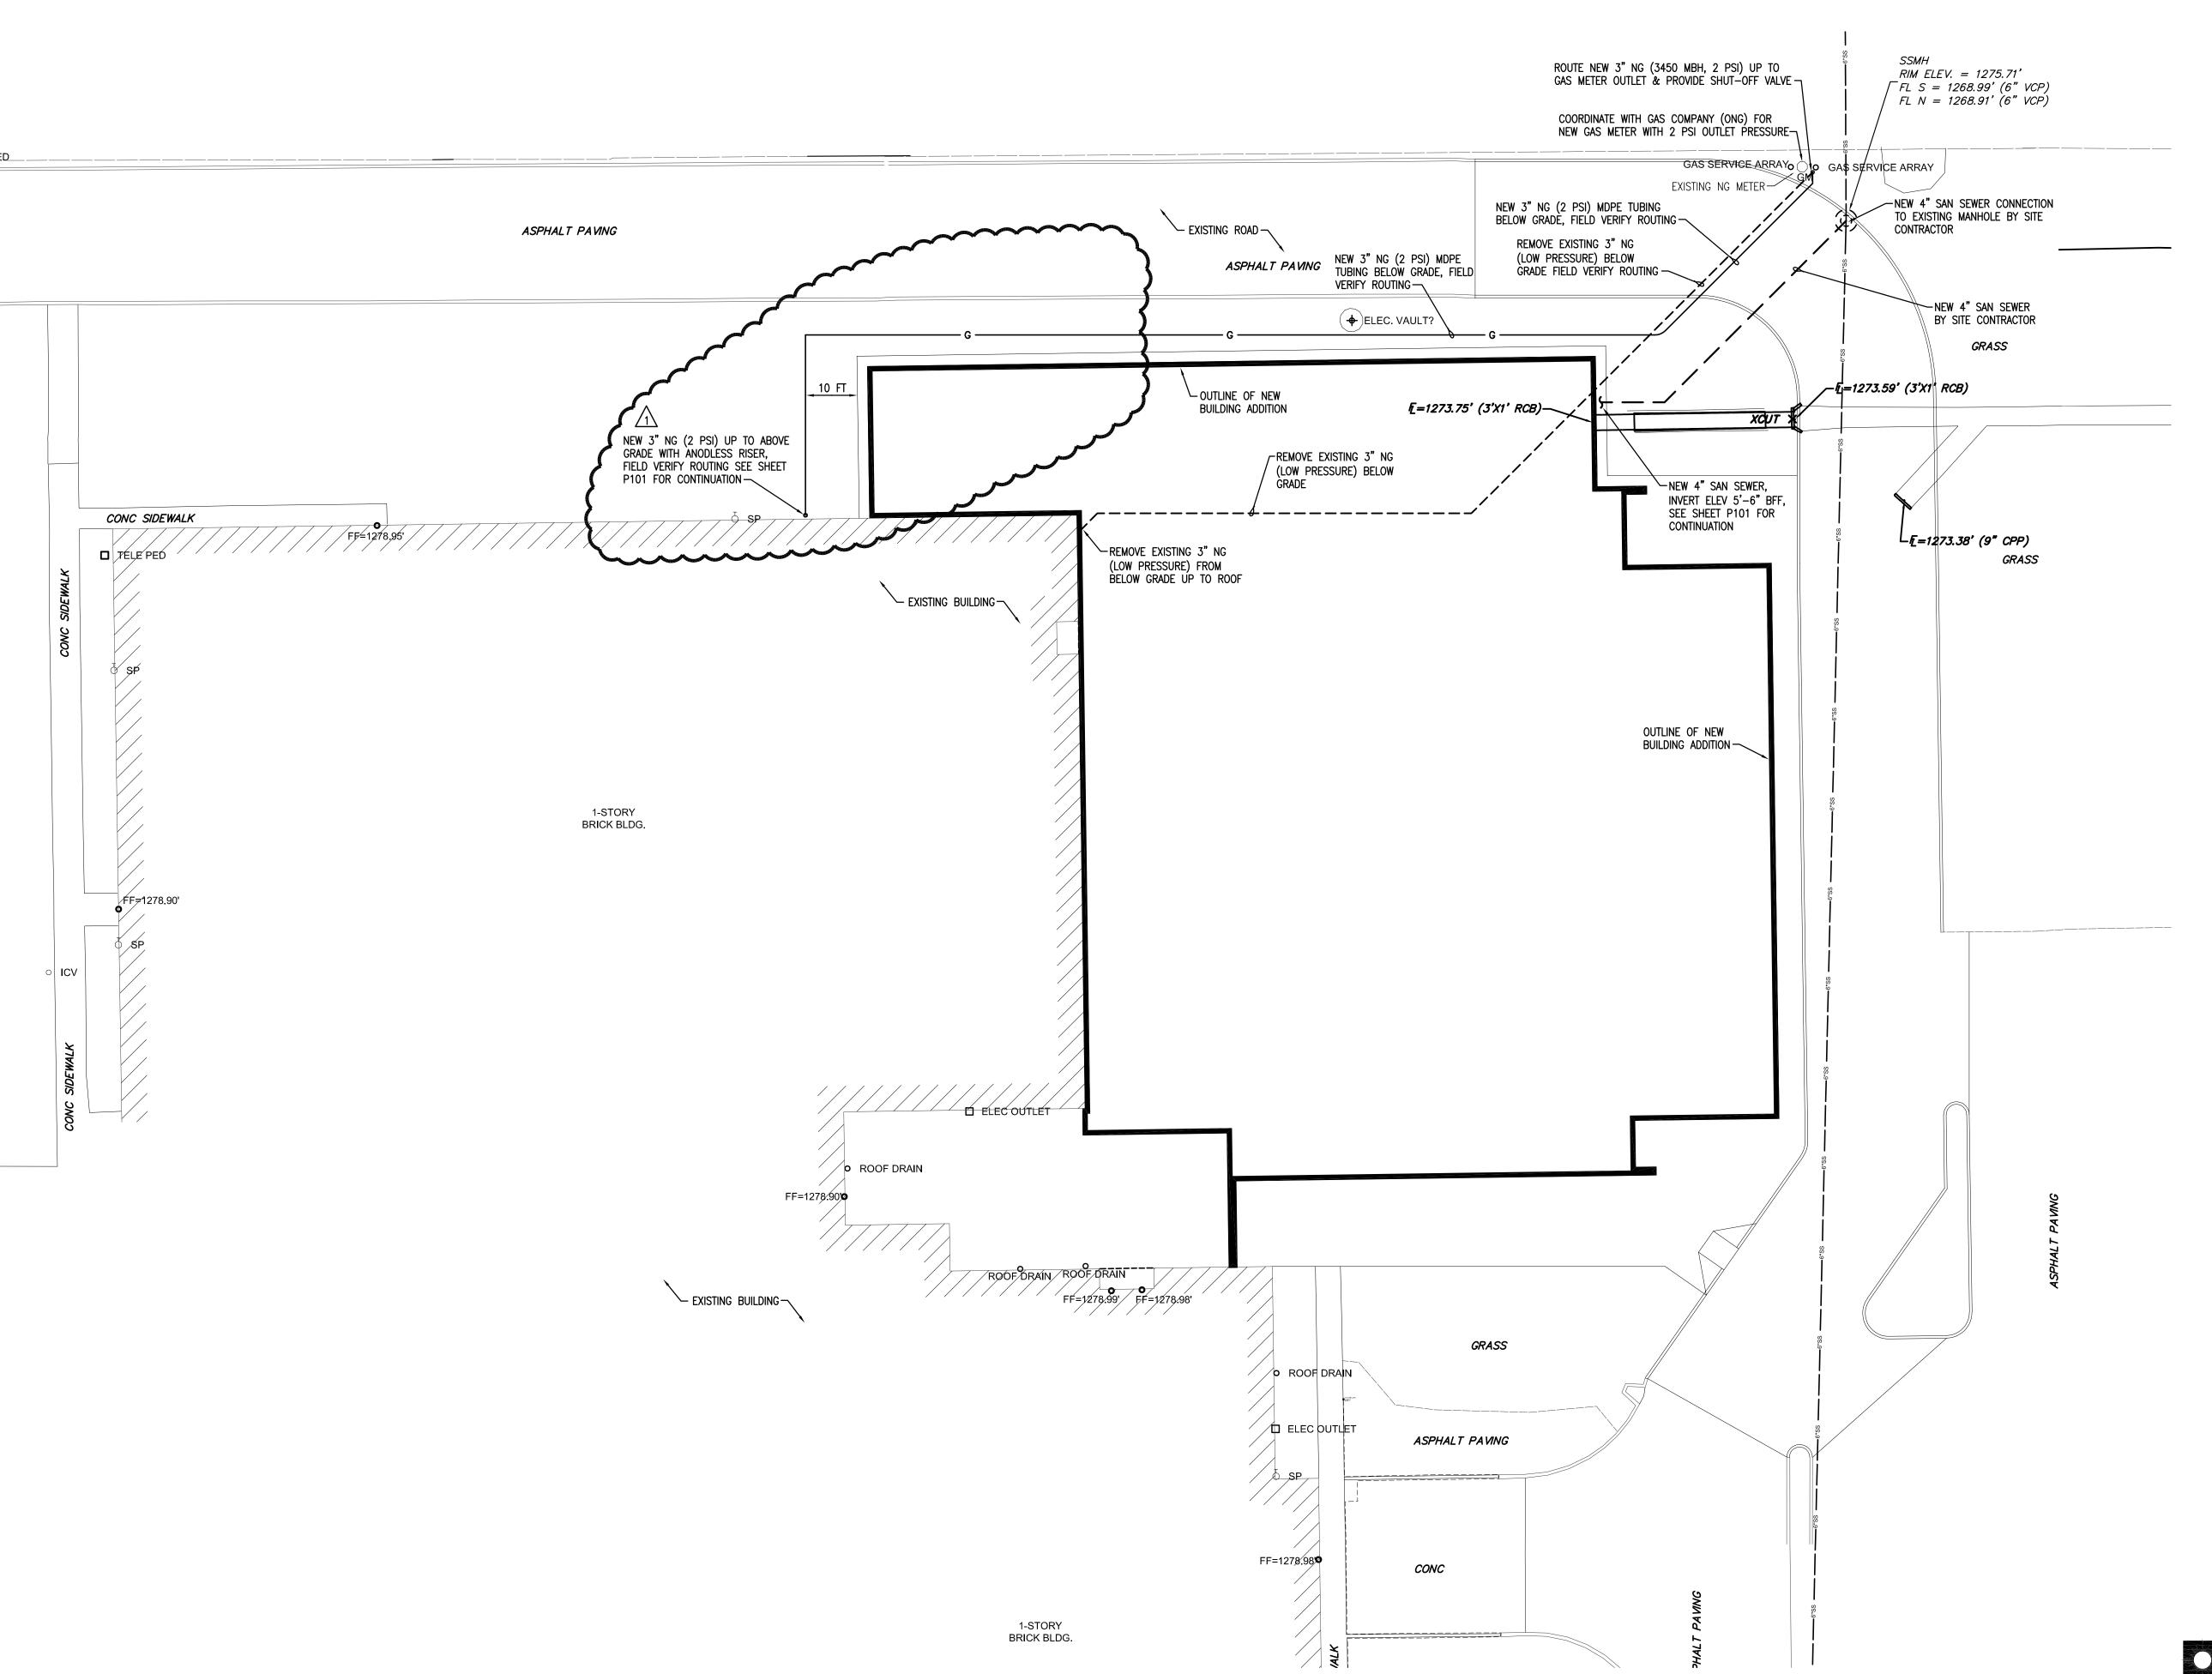
Item	Description	Attachment	
No.			
1	P100 PLUMBING PLAN – SITE – OVERALL	P100	
	Refer to drawings for changes shown in		
	clouds and deltas.		
2	P112 PLUMBING PLAN – BELOW GRADE	P101	
	Refer to drawings for changes shown in		
	clouds and deltas.		
3	P111 PLUMBING PALN – ABOVE GRADE	P111	
	Refer to drawings for changes shown in		
	clouds and deltas.		



Item No.	Description	Attachment
4	P201 PLUMBING PLAN – ROOF Refer to drawings for changes shown in clouds and deltas.	P201

#### **END OF CB-01**





1 PLUMBING PLAN - SITE - OVERALL

1/16" = 1'-0"



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MARCH 2022 date

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CLASSROOM ADDITION MOOREWEST JUNIOR HIGH SCHOOL

sheet no:

P100

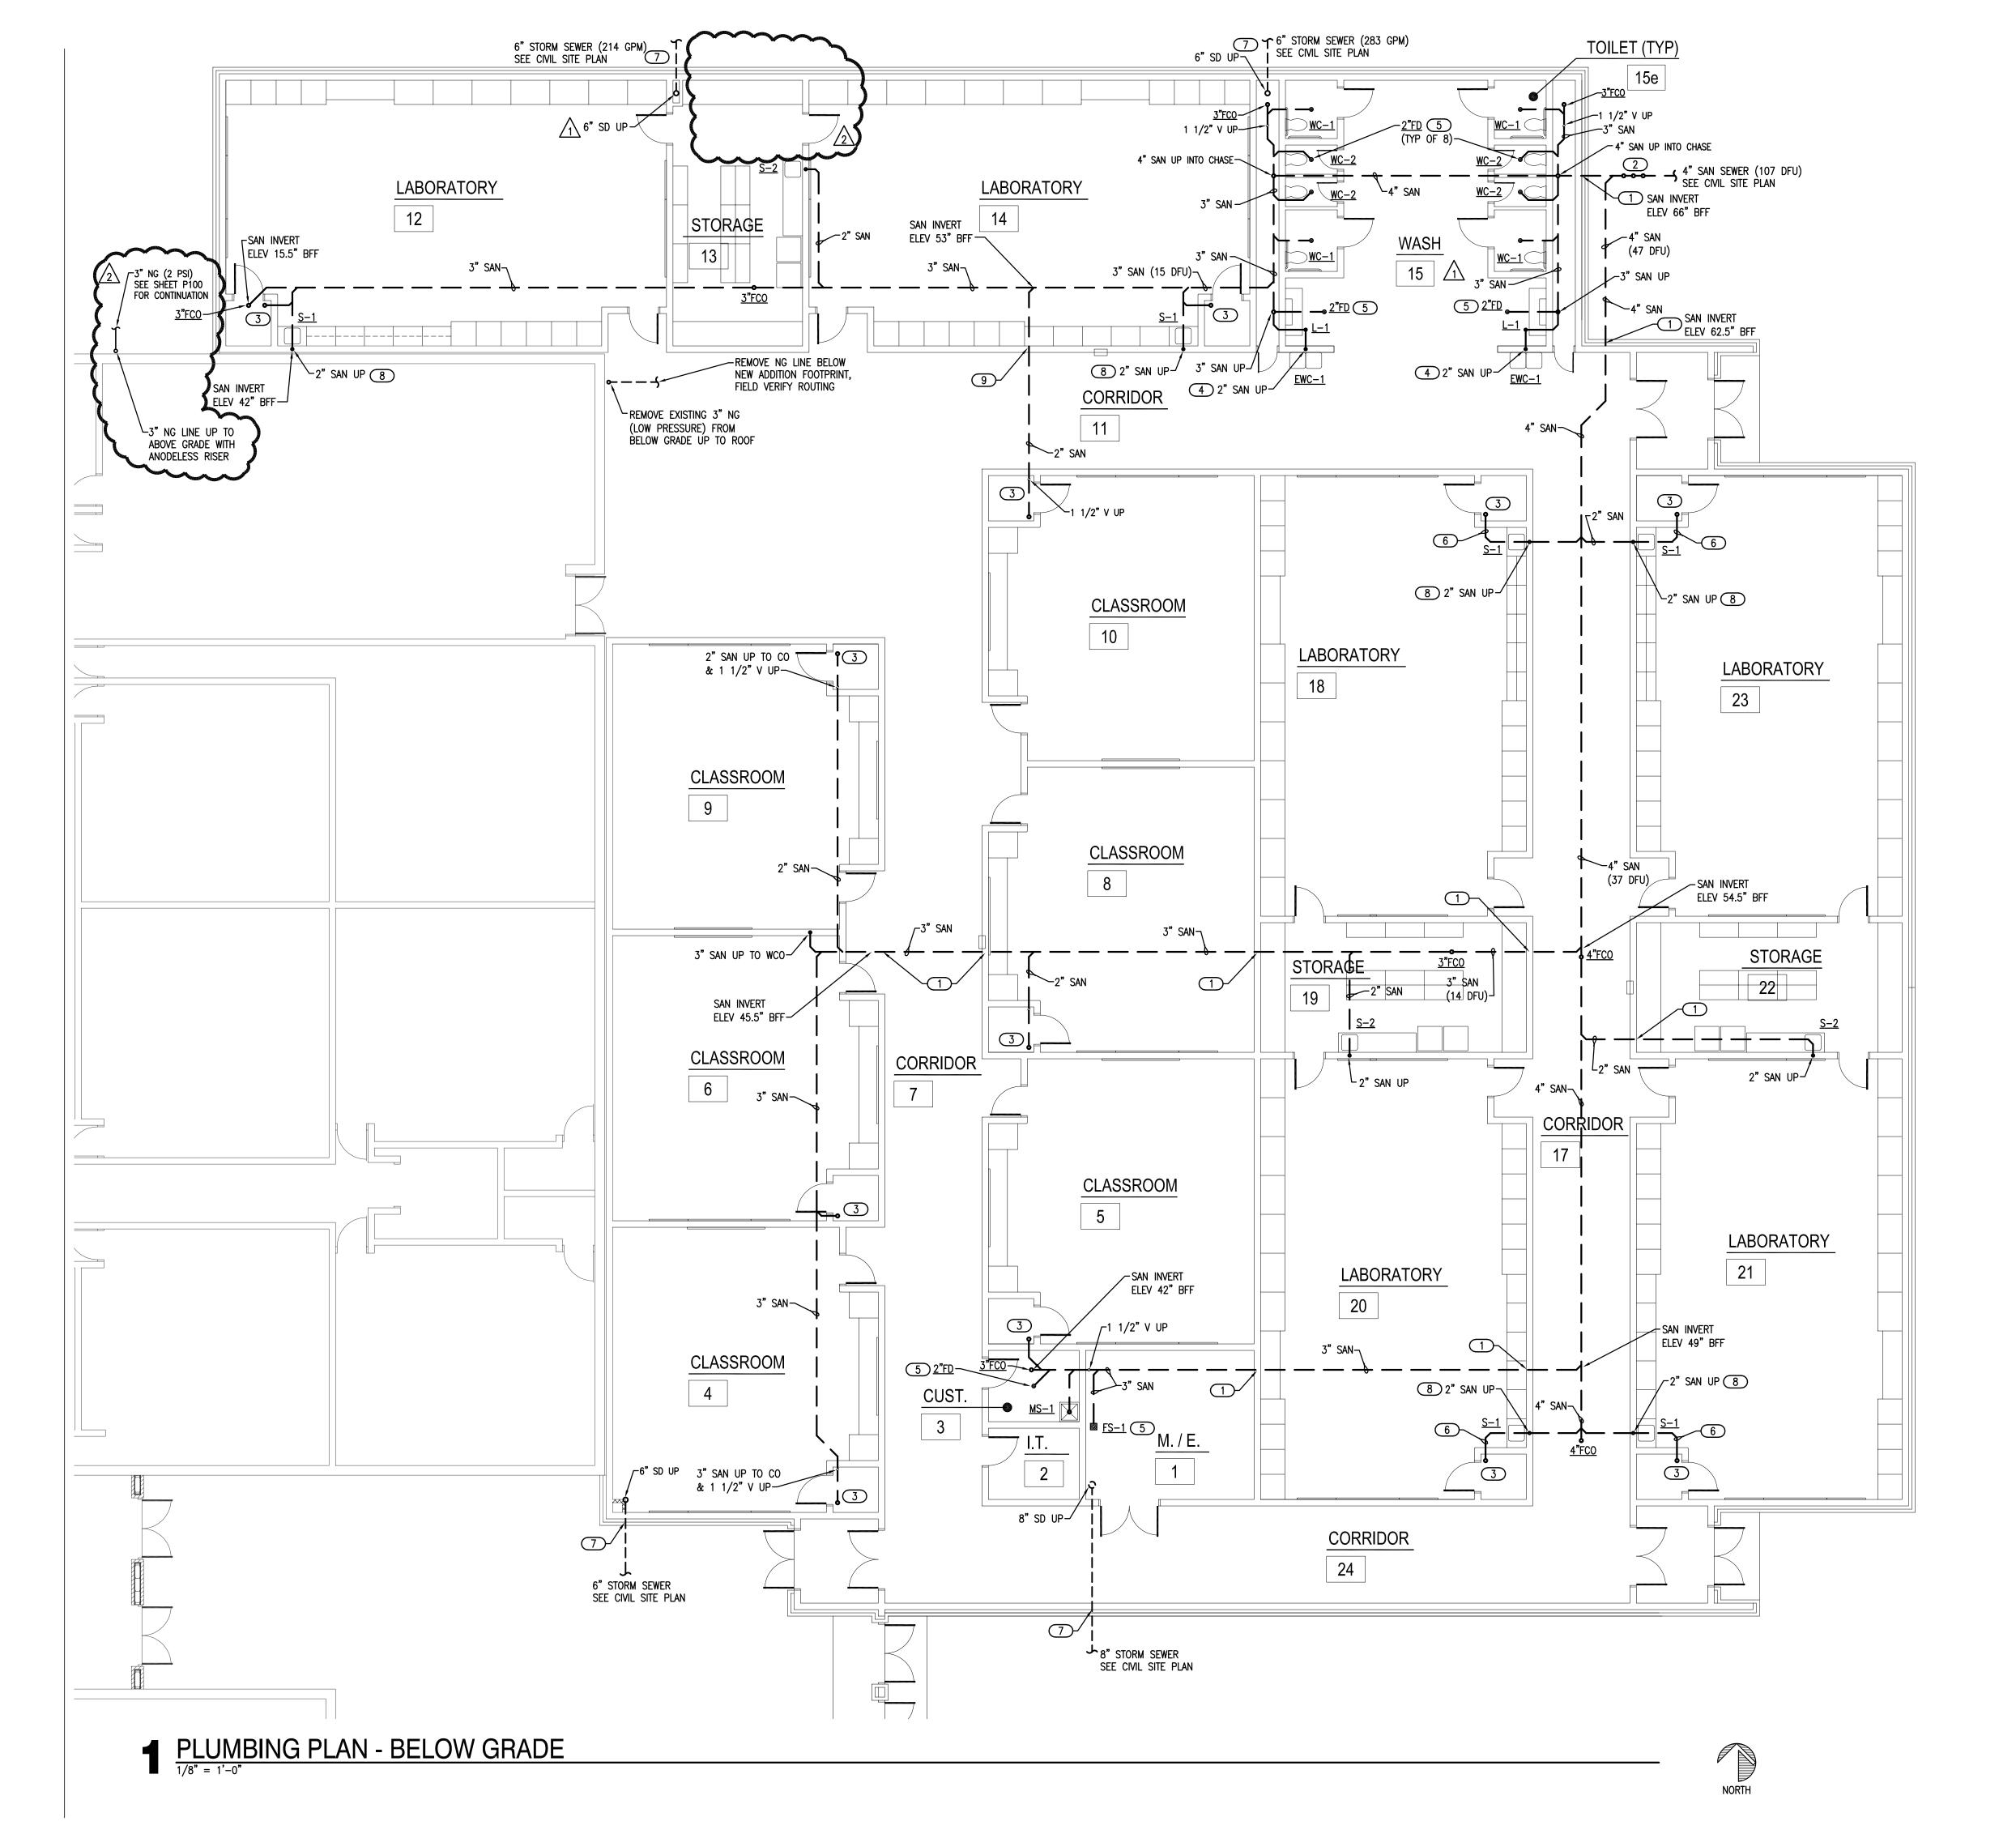


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## **GENERAL NOTES**

COORDINATE WORK WITH ALL OTHER TRADES ON SITE.

- COORDINATE ALL BELOW GRADE PIPE ROUTING WITH STRUCTURAL FOUNDATIONS AND REQUIRED PIPE SLEEVES THRU FOUNDATION PENETRATIONS.
- FIELD VERIFY EXISTING CONDITIONS PRIOR TO COMMENCING WORK.
- PRIOR TO COMMENCING WORK, COORDINATE WITH SITE CONTRACTOR FOR SANITARY SEWER AND WATER INVERT ELEVATIONS.
- REFER TO PLUMBING FIXTURE SCHEDULE ON SHEET P601 FOR FIXTURE ROUGH-IN PIPE SIZES AND ADDITIONAL SIZES ON ISOMETRIC P401.
- PIPE TRENCHES SHALL HAVE SAND BEDDING TO A MINIMUM POINT 6" ABOVE THE TOP OF PIPE. REFER TO SPECIFICATION SECTION 22 05 00.
- INSTALL BELOW FLOOR 1/2" CW LINE TYPE K COPPER OR PEX-a FOR TRAP PRIMER TO FLOOR DRAINS. SLOPE LINE CONTINUOUSLY TOWARDS DRAIN. SEE DETAIL 1/P501.

#### **KEYED NOTES**

- 1 PROVIDE CAST IRON PIPE SLEEVE FOR SANITARY PIPE BELOW GRADE BEAM. INSTALL FOAM SPACER BLOCKS TO MAINTAIN PIPE IN CENTER OF SLEEVE. COORDINATE PIPE SLEEVE INSTALLATION WITH STRUCTURAL.
- (2) INSTALL 4" SANITARY BACKWATER VALVE AND 4" EXTERIOR CLEANOUT. PROVIDE CONCRETE PAD AT GRADE. SEE DETAIL 4/P501.
- 3 ROUTE 2" SANITARY LINE UP TO 2" AFF AND INSTALL 2x4 FITTING FOR HUB DRAIN. COORDINATE INSTALLATION WITH MC. ROUTE TRAP PRIMER

LINE TO HUB DRAIN. MC TO ROUTE FURNACE CONDENSATE DRAIN LINES

4 COORDINATE WITH STRUCTURAL FOR ROUTING SANITARY UP TO ABOVE GRADE BEAM AND UP INTO WALL ABOVE.

TO HUB DRAIN. SEE DETAIL1/P501.

- 5 INSTALL BELOW FLOOR 1/2" CW LINE TYPE K COPPER OR PEX—a FOR TRAP PRIMER TO FLOOR DRAIN. SLOPE LINE CONTINUOUSLY TOWARDS DRAIN. SEE DETAIL 1/P501.
- 6 2" SANITARY LINE SERVING HUB DRAIN HAS MAXIMUM HEIGHT OF 42" FROM OPENING TO TRAP WEIR PER PLUMBING CODE. LOCATE AS REQUIRED TO ROUTE UNDER GRADE BEAM.
- 7 PROVIDE CAST IRON PIPE SLEEVE FOR STORM PIPE THRU FOUNDATION WALL. INSTALL FOAM SPACER BLOCKS TO MAINTAIN PIPE IN CENTER OF SLEEVE. COORDINATE PIPE SLEEVE INSTALLATION WITH STRUCTURAL.
- 8 ROUTE 2" SANITARY LINE BELOW GRADE BEAM WITH 2" SANITARY UP THRU GRADE BEAM TO SERVE SINK. PROVIDE CAST IRON PIPE SLEEVE THRU GRADE BEAM. INSTALL FOAM SPACER BLOCKS TO MAINTAIN PIPE IN CENTER OF SLEEVE. COORDINATE PIPE SLEEVE INSTALLATION WITH STRUCTURAL.
- 9 DROP 2" SANITARY TO GO UNDER GRADE BEAM. PROVIDE CAST IRON PIPE SLEEVE FOR SANITARY PIPE UNDER GRADE BEAM. INSTALL FOAM SPACER BLOCKS TO MAINTAIN PIPE IN CENTER OF SLEEVE. COORDINATE PIPE SLEEVE INSTALLATION WITH STRUCTURAL.



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**CLASSROOM ADDITION** MOOREWEST JUNIOR HIGH SCHOOL

sheet no:

P101



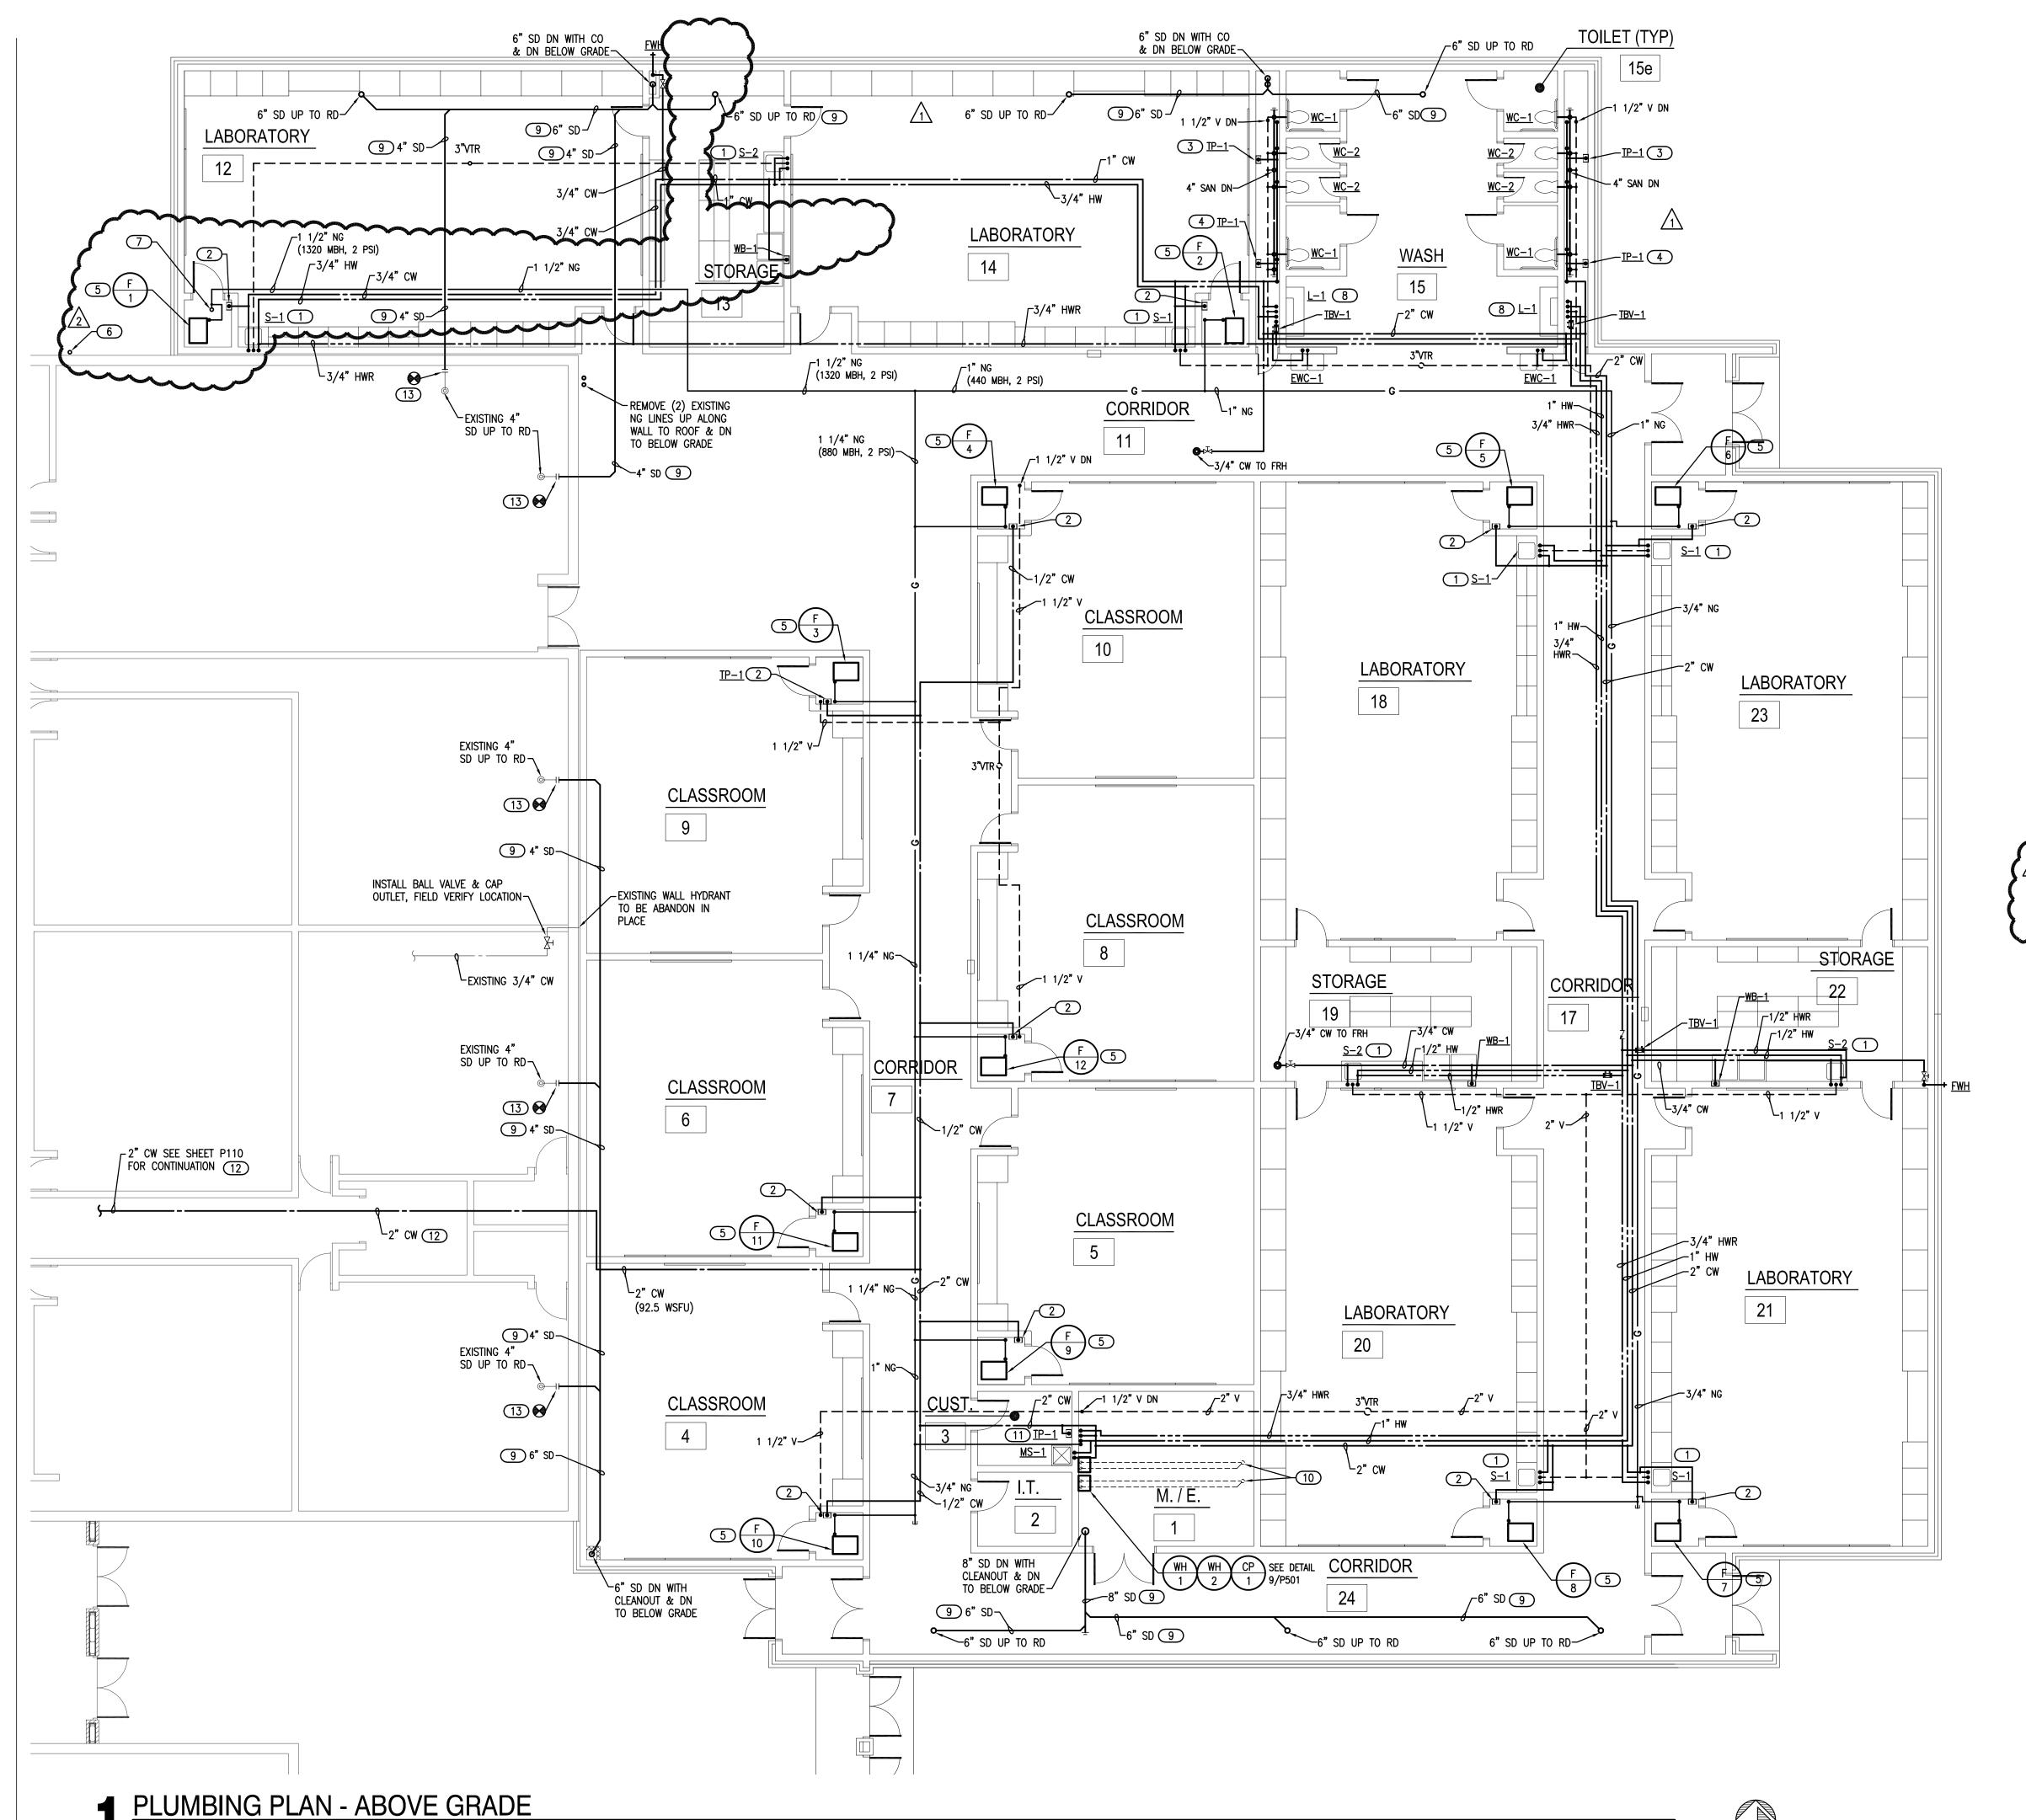
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#### **GENERAL NOTES**

. COORDINATE WORK WITH ALL OTHER TRADES ON SITE.

- 2. PROVIDE WATER HAMMER ARRESTORS (HA) ON WATER LINES TO FLUSH VALVES, SENSOR FAUCETS AND QUICK CLOSING VALVES. LOCATE UNITS IN ACCESSIBLE LOCATIONS.
- 3. SINK AND LAVATORY WATER SUPPLY STUB OUTS SHALL BE COPPER PIPE WITH SUPPORT BRACKET FASTENED IN WALL CAVITY.
- . FIRE SEAL ALL PENETRATIONS THRU RATED STRUCTURES TO MAINTAIN FIRE RATING.
- 5. REFER TO PLUMBING FIXTURE SCHEDULE ON SHEET P601 FOR FIXTURE ROUGH—IN PIPE SIZES AND ADDITIONAL SIZES ON ISOMETRIC P402.
- 6. PROVIDE ACCESS PANELS FOR ALL VALVES/DEVICES ABOVE HARD CEILINGS AND BEHIND WALLS.
- 7. ALL GAS PIPE SHALL COMPLY WITH IFGC. BRANCH LINES SHALL TAP OFF TOP OF GAS MAINS AND INSTALL SHUT-OFF VALVE ON BRANCH LINE.
- TRAP PRIMER LINES SHALL BE COPPER TYPE "K" OR PEX—a TUBING WITH
- COORDINATE HEIGHT OF EXTERIOR FREEZELESS WALL HYDRANT (FWH) WITH GC AND/OR ARCHITECT. SEAL FIXTURE FLANGE WATERTIGHT.

CONTINUOUS SLOPE TOWARDS DRAIN CONNECTION.

## **KEYED NOTES**

- 1 INSTALL THERMOSTATIC MIXING VALVE (TMV-1) BELOW SINK. CLASSROOM SINKS SEE DETAIL 8/P501. STORAGE ROOM SINKS SEE DETAIL 5/P501.
- PROVIDE 1/2" CW WITH STRAINER TO TRAP PRIMER (TP-1) IN ACCESSIBLE LOCATION IN FURNACE CLOSET. ROUTE 1/2" LINE FROM UNIT TO HUB DRAIN. COORDINATE POWER WITH EC. SEE DETAIL 1/P501.
- PROVIDE 1/2" CW WITH STRAINER TO TRAP PRIMER (TP-1) IN ACCESSIBLE LOCATION ON WALL IN PLUMBING CHASE. ROUTE (4) 1/2" LINES FROM DISTRIBUTION UNIT TO FLOOR DRAINS IN TOILET ROOMS. SEE DETAIL 1/P501.
- PROVIDE 1/2" CW WITH STRAINER TO TRAP PRIMER (TP-1) IN ACCESSIBLE LOCATION ON WALL IN PLUMBING CHASE. ROUTE (2) 1/2" LINES FROM DISTRIBUTION UNIT TO FLOOR DRAINS IN TOILET ROOM AND NEAR LAVATORY. SEE DETAIL 1/P501.
- 5 ROUTE 1/2" NATURAL GAS (2 PSI) LINE TO FURNACE. PROVIDE BALL VALVE, DRIP LEG, PRESSURE REGULATOR (2 PSI TO 7"W.C.) AND FINAL UNIT CONNECTION. COORDINATE CONNECTION WITH MC. SEE DETAIL 7/P501.
- 6 ROUTE 3" NATURAL GAS (3450 MBH, 2 PSI) UP FROM BELOW GRADE WITH SHUT-OFF VALVE AT 2'-0" ABOVE GRADE. ROUTE 3" NATURAL GAS UP ALONG WALL TO ROOF. SEE SHEET P201 FOR CONTINUATION.
- 7 ROUTE 1 1/2" NATURAL GAS (1400 MBH, 2 PSI) DOWN FROM ROOF WITH SHUT-OFF VALVE BELOW ROOF STRUCTURE. LOCATION IN ACCESSIBLE LOCATION. COORDINATE LOCATION WITH DUCTWORK.
- 8 INSTALL THERMOSTATIC MIXING VALVE (TMV-1) BELOW LAVATORY L-1.
  ROUTE 1/2" HWR LINE FROM FIXTURE WITH THERMOSTATIC BALANCING
  VALVE (TBV-1) PRIOR TO CONNECTION TO HWR MAIN SEE DETAIL
  6/P501.
- 9 INSULATED STORM DRAIN WITH SLOPE AT 1/8" PER FOOT.
- (10) WATER HEATER 2" CONCENTRIC VENT UP THRU ROOF.
- PROVIDE 1/2" CW WITH STRAINER TO TRAP PRIMER (TP-1) IN ACCESSIBLE LOCATION ON WALL IN CUST RM 3. ROUTE (3) 1/2" LINES FROM DISTRIBUTION UNIT TO FLOOR DRAIN, HUB DRAIN AND FLOOR SINK. SEE DETAIL 1/P501.
- COORDINATE WITH GC FOR CEILING REMOVAL AND REPLACEMENT FOR INSTALLING NEW COLD WATER MAIN THRU EXISTING BUILDING TO NEW
- REMOVE SECTION OF EXISTING STORM DRAIN AS REQUIRED FOR CONNECTION OF NEW 4" STORM DRAIN AND EXTEND INTO NEW ADDITION. COORDINATE WITH GC FOR CEILING REMOVAL AND REPLACEMENT TO ACCESS STORM DRAIN LINES.

# the Abla Griffin Partnership L.L.C.

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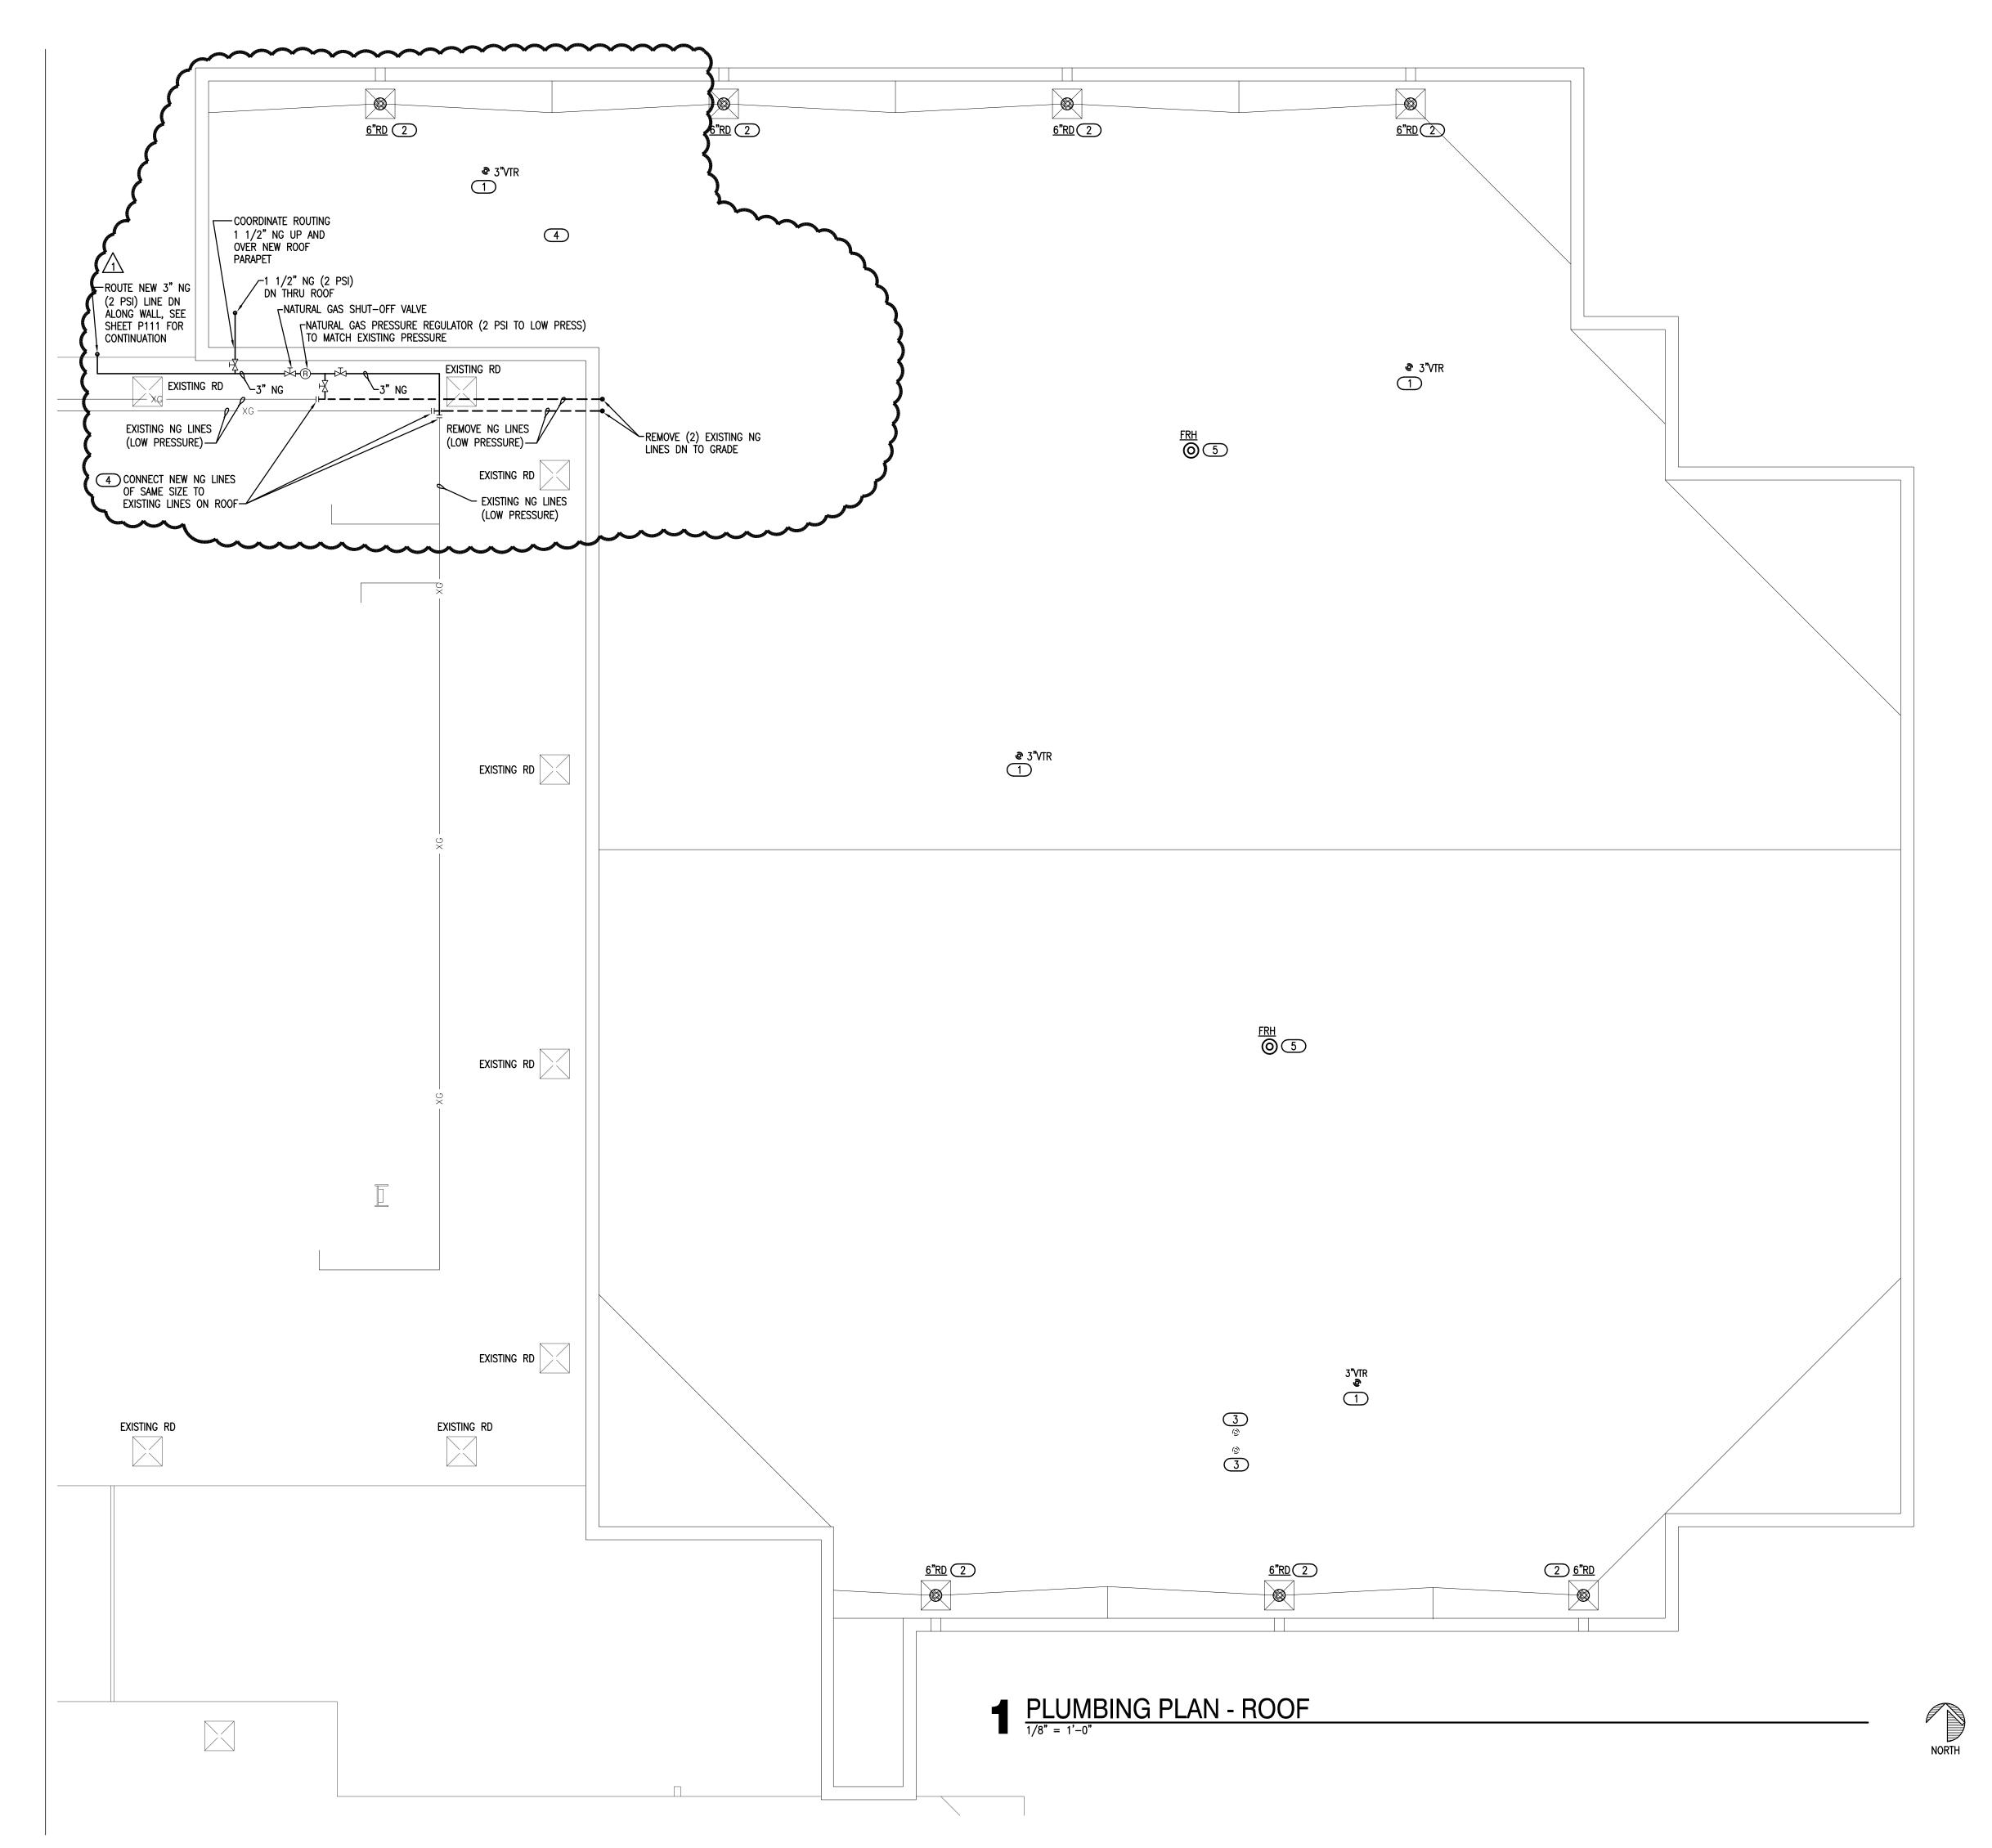
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## **GENERAL NOTES**

- COORDINATE WORK WITH ALL TRADES ON SITE.
- ALL ABOVE GRADE EXTERIOR NATURAL GAS PIPE SHALL BE CLEANED AND DEGREASED PRIOR TO BEING PRIMED THEN PAINTED YELLOW WITH WEATHER RESISTANT ZINC RICH PAINT.
- PIPE IDENTIFICATION SHALL BE THE WORD "NATURAL GAS" IN BLACK LETTERS AT 5 FT INTERVALS USING PLASTIC PIPE MARKERS OR STENCILED PAINTED LETTERS.
- ALL GAS PIPE SHALL COMPLY WITH IFGC. BRANCH LINES SHALL TAP OFF TOP OF GAS MAINS AND INSTALL SHUT-OFF VALVE ON BRANCH LINE.
- MAINTAIN MINUMUM OF 10'-0" CLEAR BETWEEN EXHAUST AND INTAKE VENTS WITH MECHANICAL EQUIPMENT AND OTHER ROOF OPENINGS.

# **KEYED NOTES**

- 1 COORDINATE INSTALLATION OF PLUMBING VENTS WITH ROOFING CONTRACTOR. INSTALL VENT A MINIMUM 10'-0" FROM ANY OPENINGS, EQUIPMENT, INTAKES OR EXHAUST VENTS.
- (2) COORDINATE INSTALLATION OF ROOF DRAIN WITH ROOFING CONTRACTOR.
- 3 COORDINATE INSTALLATION OF 2" GAS WATER HEATER CONCENTRIC VENT WITH ROOFING CONTRACTOR AND PER MANUFACTURER'S RECOMMENDATIONS. INSTALL VENT A MINIMUM 10'-0" FROM ANY OPENINGS, EQUIPMENT, INTAKES, EXHAUST VENTS AND ROOF EDGE.
- 4 ROUTE NATURAL GAS LINE (2 PSI) ON ROOF. PROVIDE MIRO INDUSTRIES MODEL 3-RAH-8 ROOF TOP SUPPORTS OR APPROVED EQUAL. INSTALL AT MAXIMUM OF 10'-0" APART (CENTER TO CENTER) ON ALL 1 1/4" NATURAL GAS PIPING OR LARGER. INSTALL AT 8'-0" APART ON 1" OR 3/4" NATURAL GAS PIPING. INSTALL AT 6'-0" APART ON 1/2" NATURAL GÁS PIPING. REFER TO GENERAL NOTES FOR PAINTING GAS' LINE. SEE DETAIL 9/P501 FOR PIPE SUPPORT DETAIL.
- 5 COORDINATE INSTALLATION OF FREEZELESS ROOF HYDRANT (FRH) WITH STRUCTURAL AND ROOFING CONTRACTOR.



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