

This addendum is applicable to work designated herein, shall be understood to be an Addendum, and as such shall be included in the Contract Agreement.

Receipt of this Addendum shall be acknowledged by the Construction Management Firm notifying this office in writing, and by any applicable subcontractor to the CM.

This addendum consists of two (2) pages with attachments of three (3) 8.5''x11'' pages and two (2) 24''x36'' sheets.

A. Drawings:

Structural

No changes.

Architectural

- 1. Sheet A102, Detail 1, Demolition Plan: added notation concerning area of work outside of Room #9. Refer to attachment.
- 2. Sheet A103, Detail 1, Reflected Ceiling Plan: added notations concerning areas of work outside Room #9 and Room #1. Refer to attachment.


Mechanical, Electrical, Plumbing, and Technology

- 1. Refer to attachments.
- 2. Please note all existing equipment (chillers and boilers) to be replaced shall remain the Owner's property and transported/stored as directed by the Owner's Representative.

B. Specifications:


No changes.

END OF ADDENDUM NO. 1

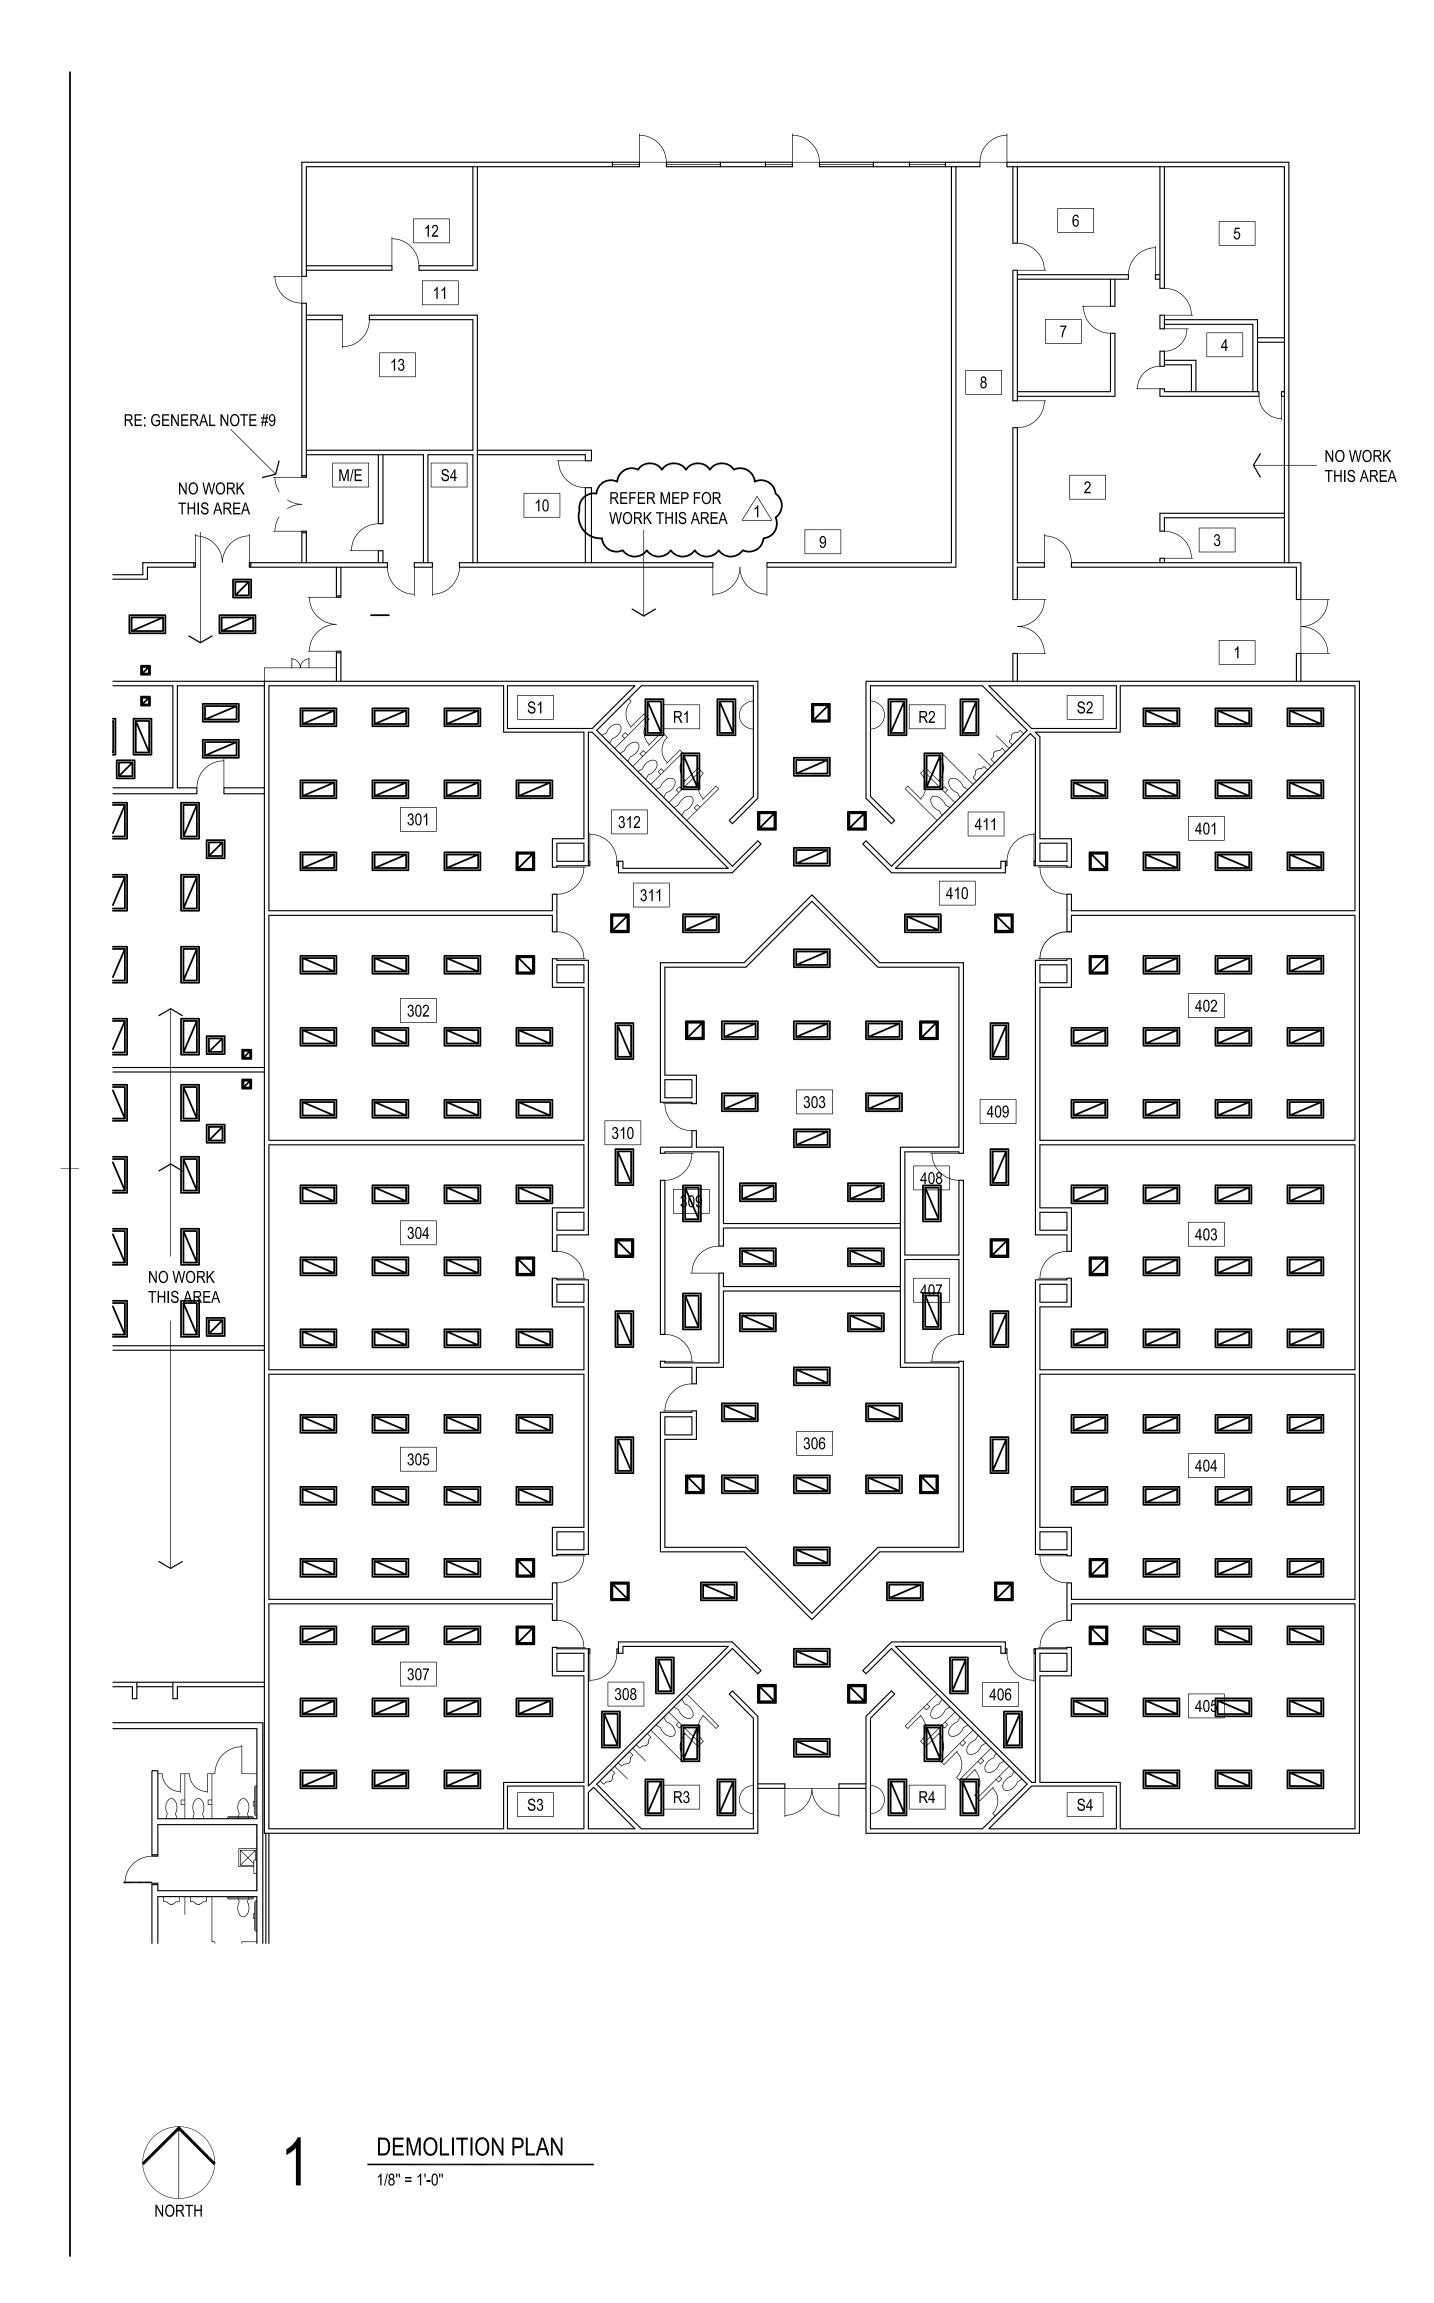


GENERAL NOTES:

- UNLESS NOTED OTHERWISE ALL ROOMS TO RECEIVE NEW 2x2 LAY-IN CEILING
- @ WORK AREA REINSTALL ALL EXISTING ELECTRICAL, (EXCLUDING EXISTING LIGHT FIXTURES), SPEAKERS, FIRE PROTECTION, ETC. PROVIDE ALL MATERIALS NECESSARY FOR A COMPLETE INSTALLATION
- REMOVE EXISTING LIGHT FIXTURES AS REQUIRED BY CODE. RE: ELECTRICAL FOR NEW LIGHT FIXTURE INFORMATION
- REMOVE EXISTING MECHANICAL DEVIICES AS REQUIRED BY CODE. 4. **RE: MECHANICAL FOR NEW DEVICES.**
- REFER PLUMBING AND MECHANICAL SHEETS FOR ROOF PENETRATION LOCATIONS. PROVIDE ALL ROOFING MATERIALS REQUIRED TO MEET MFR. REQUIRMETS FOR WARRANTY. PROVIDE WATER TIGHT INSTALLATION.
- CONTRACTOR TO MOVE FURNITURE AS NECESSARY FOR INTERIOR HVAC AND CEILING WORK.
- PROTECT EXISTING SMARTBOARDS AS DIRECTED BY MPS PERSONNEL. REPLACE ALL DAMAGED DEVICES.
- CONTRACTOR SHALL THOROUGHLY CLEAN EXISTING AFFECTED AREAS AFTER COMPLETION OF WORK.
- REMOVE EXISTING H., M. DOOR AND FRAME AND PREPARE OPENING TO RECEIVE NEW H.M. DOOR AND FRAME

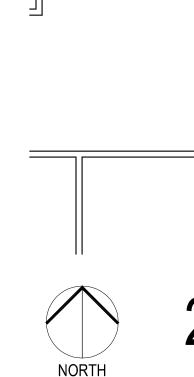


DOOR AND FRAME

HARDWARE SET #1

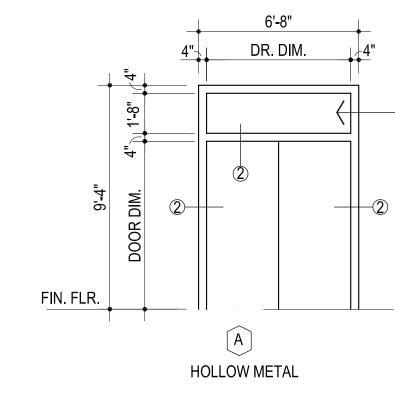


4

DOOR FRAME ELEVATIONS

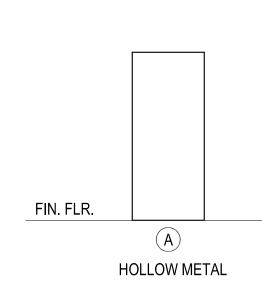

DOOR ELEVATION

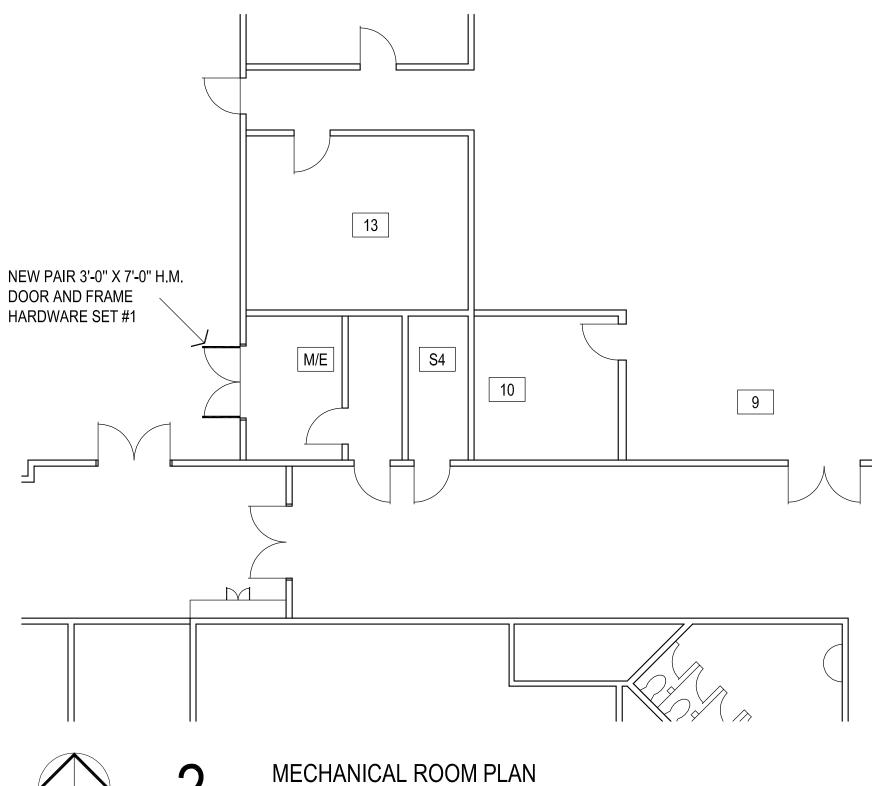

1/8" = 1'-0"

- INSULATED PANEL

H.M. DOORS & FRAMES : SHERWIN-WILLIAMS - SW6992 - INKWELL



201 N. BROADWAY SUITE 210 MOORE, OK. 73160 405.735.3477 AGP@theAGP.net www.theAGP.net

KFC ENGINEERING

STRUCTURAL

SALAS O'BRIEN MECHANICAL / ELECTRICAL



CG drawn by MA checked by

> MARCH 2024 date

revisions ADDENDUM #1

MOORE PUBLIC SCHOOLS BOARD OF EDUCATION MOORE, OKLAHOMA




HVAC REPLACEMENT KINGSGATE ELEMENTARY SCHOOL

sheet no:




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NORTH

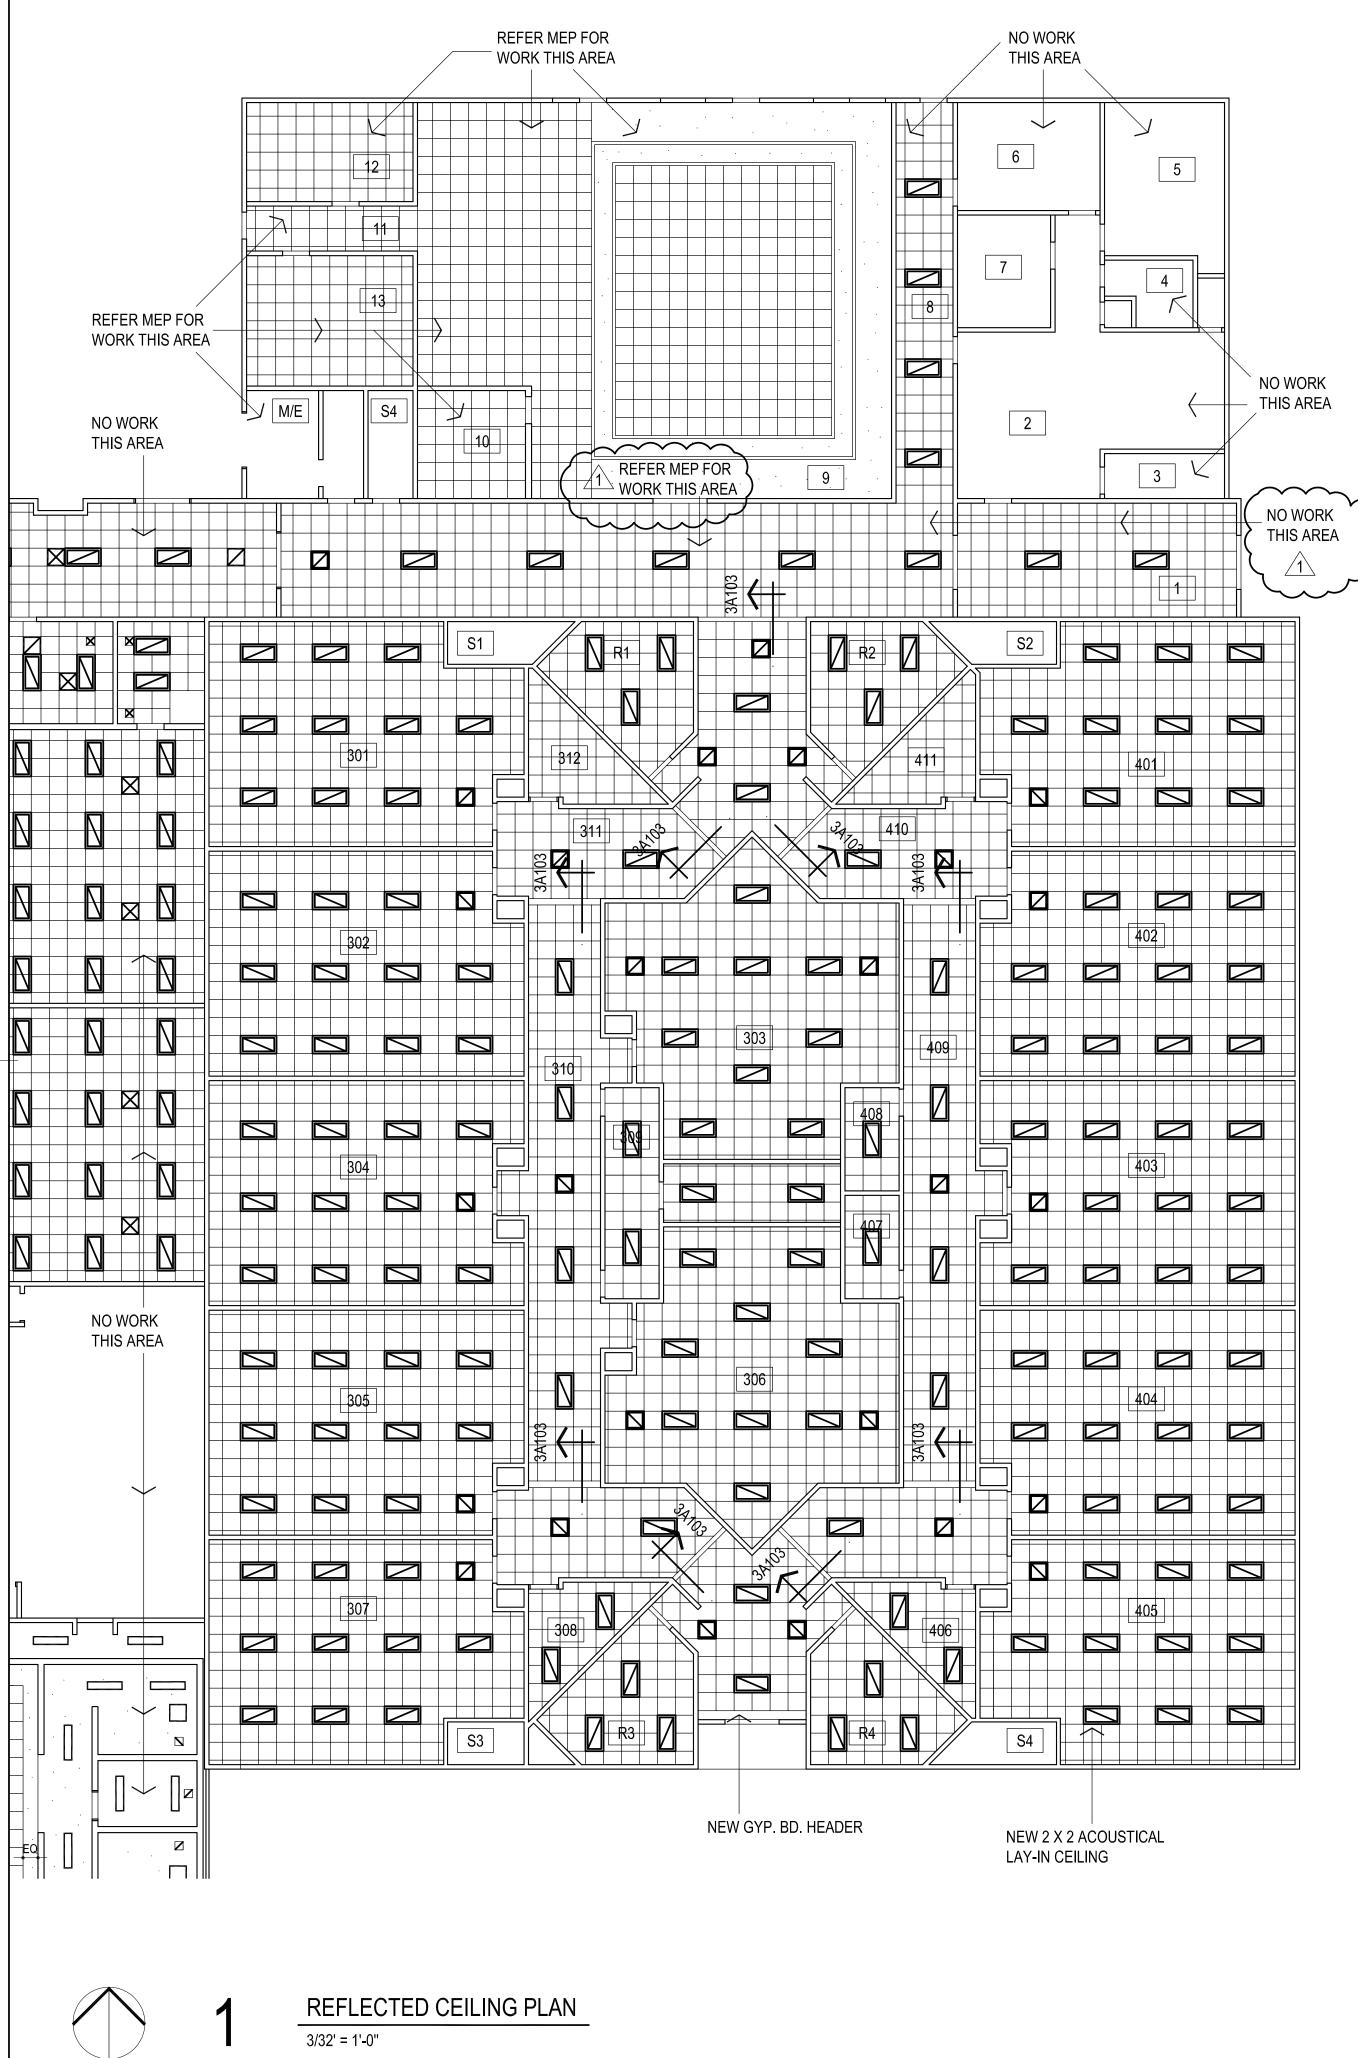

LEGEND:

\boxtimes	MECHANICAL OPENINGS
ЭШ	ELECTRICAL FIXTURES

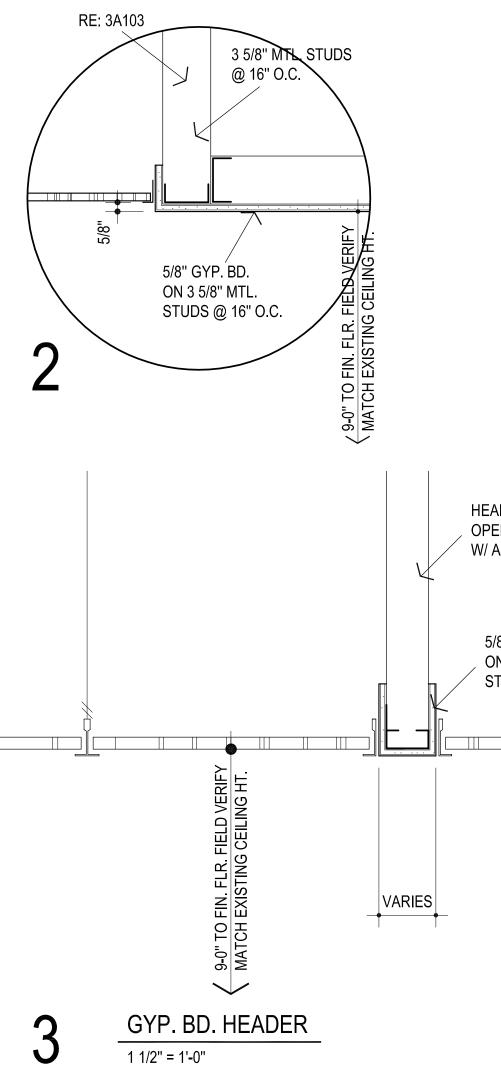 \odot CEILING MOUNTED SMOKE DETECTOR, RE: ELEC

NOTES:

- 1. REFER MECHANICAL & ELECTRICAL FOR ANY ADDITIONAL CEILING MOUNTED FIXTURES
- 2. REFER TO SHEET A100 FOR LOCATIONS OF FIRE-RATED WALLS
- 3. ALL CORRIDOR CEILING TILES TO HAVE TEGULAR EDGE. ALL OTHER ROOMS (CLASSROOMS, ETC.) SHALL HAVE SQUARE EDGES.
- 4. REVISE EXISTING FIRE SUPPRESSION HEADS AS REQUIRED W/ NEW CEILING HEIGHTS - APPROX. 15 TOTAL



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KFC ENGINEERING

STRUCTURAL

SALAS O'BRIEN MECHANICAL / ELECTRICAL

HEADER STRUCTURE TO SPAN WIDTH OF OPENING / CORRIDOR - ANCHOR TO WALLS W/ APPROPRIATE ANCHORS @ 16" O.C. MAX., TYP.

5/8" GYP. BD. , ON 3 5/8" MTL. STUDS @ 16" O.C.

2 X 2 ACOUSTICAL LAY-IN CEILING

> **REVISE CEILING HEIGHTS AS REQUIRED W/ NEW UNIT LOCATIONS**



CG drawn by

MA checked by

MARCH 2024 date

revisions 1 ADDENDUM #1

MOORE PUBLIC SCHOOLS BOARD OF EDUCATION MOORE, OKLAHOMA



HVAC REPLACEMENT KINGSGATE **ELEMENTARY SCHOOL**

sheet no:



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ADDENDUM No. 1

Client: Abla Griffin Partnership Project Name: Kingsgate Elem HVAC Reno Project Location: Oklahoma City, OK

Issue Date: March 28, 2024

Owner: Moore Public Schools Engineer: Salas O'Brien



Project No. 2024-01144-00

To: Prospective Bidders.

This Addendum forms a part of the Contract Documents and modifies the Bidding Documents dated March 14, 2024, (and previous Addenda), with amendments and additions noted below. This Addendum consists of (1) page and (1) attachment. Index of Attachments

Earthsmart Controls

Acknowledge receipt of this Addendum in the space provided on the Bid Form. Failure to do so may disqualify Bidder.

CHANGES TO BIDDING REQUIREMENTS

• The attached Earthsmart Temperature Control proposal shall be included as part of the mechanical bid for this project.

END OF ADDENDUM [01]



5305 N Santa Fe Avenue Oklahoma City, OK 73118

www.earthsmartcontrols.com

Phone: (405) 778-8008 Fax: (866) 676-5602

To: Moore Kingsgate Elementary Addition Attn: Estimator

March 28, 2024

This is a proposal to provide controls for the Moore Kingsgate Elementary School HVAC Replacement project.

RTU (1)

- Provide and install Honeywell controls.
- Install communication, controller, supply air sensor, fan status, compressor statuses, digital space temperature sensor and CO2 sensor to control outside air damper (damper actuator by others).
- Commission the units to ensure proper operation.

Split Systems (14)

- Provide and install Honeywell controls.
- Install communication, controller, supply air sensor, fan status, compressor status, digital space temperature sensor and CO2 sensor to control outside air damper (damper actuator provided by EarthSmart Controls).
- Commission the units to ensure proper operation.

EF (1)

- Provide and install controls for the exhaust fans that occupy with Building occupancy.
- Commission the unit to ensure proper operation.

GPS Ionizers (15)

- Provide and install 15 new GPS-FC48-AC ionizers.
- Commission the unit to ensure proper operation.

Honeywell WEBS N4 Frontend

- Tie to existing WEB-8000 onsite and integrate N4 supervisor station (graphical user interface).
- Provide a 25 Device JACE to allow for future expansion.
- Provide 4 hours of user training.
- Provide 1 year parts and labor warranty.
- Provide graphical representations of equipment listed above.
- Provide custom trending and alarming.
- Provide scheduling capabilities and remote access.

We thank you for the opportunity to bid and look forward to working with you soon.

If you have any questions, please feel free to contact us at (405) 778-8008.

Continued on next page...



5305 N Santa Fe Avenue Oklahoma City, OK 73118

www.earthsmartcontrols.com

Phone: (405) 778-8008 Fax: (866) 676-5602

Exclusions for total job: Any wiring above 24V, smoke detectors, RTU damper actuators and anything not mentioned in this proposal.

The total price for the control work above is: \$72,625.00 Seventy-Two Thousand Six Hundred and Twenty-Five Dollars

Erin Bevill Controls Manager EarthSmart Controls, LLC

Company:	Signature:
Date:	Printed Name:
Title:	PO #: