GAS LOAD TABLE					
<u>-</u>	INPUT(MBH)	REQUIRED PRESSURE	REQUIRED REGULATOR	SYSTEM PRESSURE	NOTES
F-1	66	7"	MAXITROL 325-3L	2 PSI	1,2,3,5
F-2	66	7"	MAXITROL 325-3L	2 PSI	1,2,3,5
F-3	66	7"	MAXITROL 325-3L	2 PSI	1,2,3,5
F-4	66	7"	MAXITROL 325-3L	2 PSI	1,2,3,5
F-5	66	7"	MAXITROL 325-3L	2 PSI	1,2,3,5
F-6	66	7"	MAXITROL 325-3L	2 PSI	1,2,3,5
F-7	66	7"	MAXITROL 325-3L	2 PSI	1,2,3,5
F-8	66	7"	MAXITROL 325-3L	2 PSI	1,2,3,5
F-9	66	7"	MAXITROL 325-3L	2 PSI	1,2,3,5
F-10	44	7"	MAXITROL 325-3L	2 PSI	1,2,3,5
F-11	44	7"	MAXITROL 325-3L	2 PSI	1,2,3,5
F-12	66	7"	MAXITROL 325-3L	2 PSI	1,2,3,5
F-13	66	7"	MAXITROL 325-3L	2 PSI	1,2,3,5
F-14	44	7"	MAXITROL 325-3L	2 PSI	1,2,3,5
F-15	44	7"	MAXITROL 325-3L	2 PSI	1,2,3,5
F-16	44	7"	MAXITROL 325-3L	2 PSI	1,2,3,5
RTU-1	260	7"	MAXITROL 325-5LB	2 PSI	1,2,4,5
TOTAL LOAD	1206 MBH				

NOTES:

- INSTALL AND VENT REGULATOR PER MANUFACTURER'S RECOMMENDATIONS.
- 2. COORDINATE WITH MECHANICAL CONTRACTOR FOR EQUIPMENT LOCATIONS AND REQUIRED CONNECTION.
- 3. PROVIDE INDOOR VENT LIMITER MAXITROL 12A09.
- 4. PROVIDE EXTERIOR VENT PROTECTOR MAXITROL 13A15-5.
- GAS PIPING DESIGNED FOR PRESSURE OF 2 PSI WITH PRESSURE DROP OF 1 PSI AND TOTAL LENGTH OF 1000 FEET.

GENERAL PLUMBING NOTES

- 1. THESE DRAWINGS SHALL NOT BE SCALED. SEE ARCHITECTURAL/CIVIL DRAWINGS FOR DIMENSIONAL INFORMATION. THIS ENGINEER WILL NOT BE LIABLE FOR MISCALCULATED PRODUCT TAKE-OFFS DUE TO SCALING OF DRAWINGS.
- 2. ALL SANITARY PIPING SHALL HAVE A 1/8" PER FOOT SLOPE UNLESS OTHERWISE NOTED. 2" SANITARY OR SMALLER SHALL HAVE A 1/4" PER FOOT SLOPE.
- 3. VALVES AND FITTINGS SHALL BE OF SAME SIZE AS THE LINE ON WHICH THEY ARE LOCATED, UNLESS OTHERWISE INDICATED ON DRAWINGS.
- 4. CONTRACTOR SHALL COORDINATE ALL WORK WITH OTHER TRADES.
- CONTRACTOR SHALL FIELD VERIFY ALL GIVEN MEASUREMENTS PRIOR TO LAYING AND CONNECTING ALL SANITARY AND WASTE PIPING AND NOTIFY ENGINEER OF ANY DISCREPANCIES.
- CONTRACTOR SHALL BE RESPONSIBLE FOR MAINTAINING FIRE RATING AND WEATHERPROOFING INTEGRITY OF ALL PIPING AND PENETRATIONS.
- . ALL WATER SUPPLY AND SANITARY LINES SHALL BE RUN AS CLOSE TO PLANS AS POSSIBLE WITH NO CHANGES IN SIZING.
- CHANGES IN THE DIRECTION OF SANITARY DRAIN PIPING SHALL NOT BE MADE WITH FITTINGS WHICH WILL CAUSE EXCESSIVE REDUCTION IN THE VELOCITY OF FLOW OR CREATE ANY OTHER ADVERSE EFFECT UNLESS PHYSICALLY IMPOSSIBLE (I.E.: USE OF SANITARY TEE IN A HORIZONTAL CONNECTION, USE OF A DOUBLE SANITARY TEE IN A VERTICAL STACK, IN GENERAL, USE OF SHORT—RADIUS FITTINGS FOR BRANCH TO HOUSE DRAIN OR STACK CONNECTION).
- CONTRACTOR SHALL GIVE 48 HOURS HOUR EMERGENCY LOCATE NOTICE TO APPLICABLE UTILITY COMPANY PRIOR TO PERFORMING WORK INVOLVING UTILITIES.
- 10. ALL DRAINAGE PIPING SHALL BE MARKED WITH THE SEAL OF APPROVAL OF THE NATIONAL SANITATION FOUNDATION.
- 11. ROUTE ALL PIPING CONCEALED ABOVE CEILINGS, WITHIN WALLS, OR IN CHASES. PIPING EXPOSED SHALL BE SLOPED AND PAINTED TO MATCH ARCHITECTURAL FINISHES. PIPING IN MECHANICAL ROOMS MAY BE EXPOSED.
- 12. CONTRACTOR SHALL VERIFY INVERT ELEVATIONS OF SEWERS TO WHICH NEW SEWER LINES ARE TO BE CONNECTED BEFORE INSTALLATION OF NEW SEWER LINE.
- 13. ALL VENTS THROUGH ROOF SHALL BE MIN. 10'-0" FROM ANY AIR INTAKES.
- 14. CONTRACTOR SHALL INSTALL DIELECTRIC UNIONS AT CONNECTIONS OF DISSIMILAR METALS.
- 15. CONTRACTOR SHALL ROUGH—IN ALL WASTES AND SUPPLIES TO SPECIAL EQUIPMENT ACCORDING TO MANUFACTURER'S SHOP DRAWINGS AND MAKE FINAL CONNECTIONS. ALL SUPPLIES SHALL BE VALVED. INSTALL VACUUM BREAKERS WHERE REQUIRED BY CODE.
- 16. DO NOT PENETRATE WALL FOOTINGS WITH PIPING, COORDINATE WITH GENERAL CONTRACTOR TO DROP FOOTINGS AS REQUIRED TO CLEAR PLUMBING SERVICES WHERE ABSOLUTELY NECESSARY. ALL PIPING PENETRATING A BEARING WALL OR FOOTING MUST BE SLEEVED AND LOCATION APPROVED BY STRUCTURAL ENGINEER. PROVIDE LINK-SEALS IN ALL PENETRATIONS OF EXTERIOR WALLS.
- 17. ALL PIPING SHALL BE INSTALLED AS HIGH AS POSSIBLE IN PROVIDED CEILING SPACE.
- 18. COORDINATE PIPING INSTALLATION AS TO NOT INTERFERE WITH HVAC EQUIPMENT ACCESS.
- 19. ANY ERRORS OR AMBIGUITIES IN THE PLANS AND/OR SPECIFICATIONS THAT ARE DISCOVERED BY THE CONTRACTOR SHALL BE REPORTED TO THE ARCHITECT/ENGINEER BEFORE WORK IS STARTED. OMISSION OF PARTICULAR REFERENCE TO ANY ITEM NECESSARY FOR COMPLETE INSTALLATION AND PROPER OPERATION THEREOF SHALL NOT RELIEVE THE CONTRACTOR OF THE RESPONSIBILITY OF FURNISHING THE SAME AT NO EXTRA COST. THE CONTRACTOR IS RESPONSIBLE FOR REVIEWING ALL CONSTRUCTION DOCUMENTS FOR INFORMATION PRIOR TO BID.
- 20. VERIFY WITH ARCHITECT ON ALL EQUIPMENT AND FIXTURES REQUIRING PLUMBING PRIOR TO BID. COORDINATE EXACT LOCATIONS AND CONNECTIONS.
- 21. ALL WORK SHALL BE IN COMPLIANCE WITH STATE AND LOCAL CODES.
- 22. CONTRACTOR SHALL PAY ALL FEES, PERMITS, LICENSES, ETC. NECESSARY FOR PROPER COMPLETION OF WORK.
- 23. INSTALL ALL EQUIPMENT IN ACCORDANCE WITH MANUFACTURER'S RECOMMENDATIONS.


PLUMBING PIPING LINETYPES		
<u>LINETYPE</u>	<u>DESCRIPTION</u>	
	DEMOLITION	
	GAS	
	SANITARY ABOVE GRADE	
	SANITARY BELOW GRADE	
	STORM ABOVE GRADE	
	STORM BELOW GRADE	
	VENT ABOVE GRADE	
	VENT BELOW GRADE	
	COLD WATER	
	COLD WATER BELOW GRADE	
	HOT WATER	
	HOT WATER BELOW GRADE	
	RECIRC WATER	
	RECIRC WATER BELOW GRADE	

PLUMBING PIPING LEGEND				
—	CIRCUIT SETTER			
→ ↓	BALL VALVE OR SHUT-OFF VALVE			
 	SPRING CHECK VALVE			
	END CAP			
	NEW TO EXISTING PIPE CONNECTION			
	FLOW DIRECTION ARROW			
lacktriangle	NEW TO EXISTING POINT OF CONNECTION SYMBOL			
•	PIPE CONNECTION			
	HAMMER ARRESTOR (PISTON TYPE)			
\Diamond	HAMMER ARRESTOR (BELLOWS TYPE)			
	PIPING LINEWEIGHT: NEW/DEMOLITION			

PIPING LINEWEIGHT: EXISTING

PLUMBING ABBREVIATIONS					
AG ADD ADDL ADJ AFF AFG ALT BG CO COU DN DS EC ECO EQ FCO FLR FS FT F GAL GC GPM GI GW HW HWR	ABOVE GRADE ADDENDUM ADDITIONAL ADJUSTABLE ABOVE FINISH FLOOR ABOVE FINISH GRADE ALTERNATE BELOW GRADE CLEANOUT COLUMN COLD WATER DOWN DOWNSPOUT ELECTRICAL CONTRACTOR EXTERIOR CLEANOUT EQUAL FLOOR CLEANOUT FLOOR DRAIN FLOOR FLOOR SINK FOOT (FEET) FURNACE GALLON GENERAL CONTRACTOR GALLONS PER MINUTE GREASE INTERCEPTOR GREASE WASTE HOT WATER HOT WATER RETURN	MAU MC MECH MIN NG NTS NPCW ORD OS OSD PC PLBG PRES QTY RD SAN SCH SD SPEC SS TEMP TYP UR V VTR W/ WCO WC	PLUMBING PRESSURE QUANTITY ROOF DRAIN ROOFTOP UNIT SANITARY SCHEDULE STORM DRAIN		

	PLUMBING SHEET INDEX		
P000	PLUMBING TITLE SHEET		
P100	OVERALL PLUMBING PLAN		
P101	PLUMBING PLAN		
P201	PLUMBING ROOF PLAN		
P501	PLUMBING DETAILS		

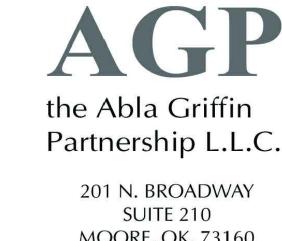

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HOUCHIN ELEMENTARY
HVAC UPGRADE

sheet no:

P000




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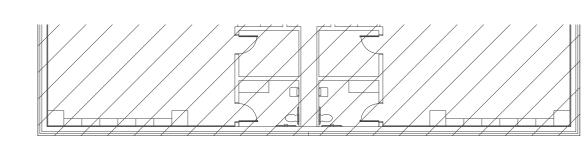
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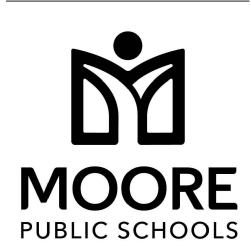


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HOUCHIN ELEMENTARY **HVAC UPGRADE**

sheet no:

P100


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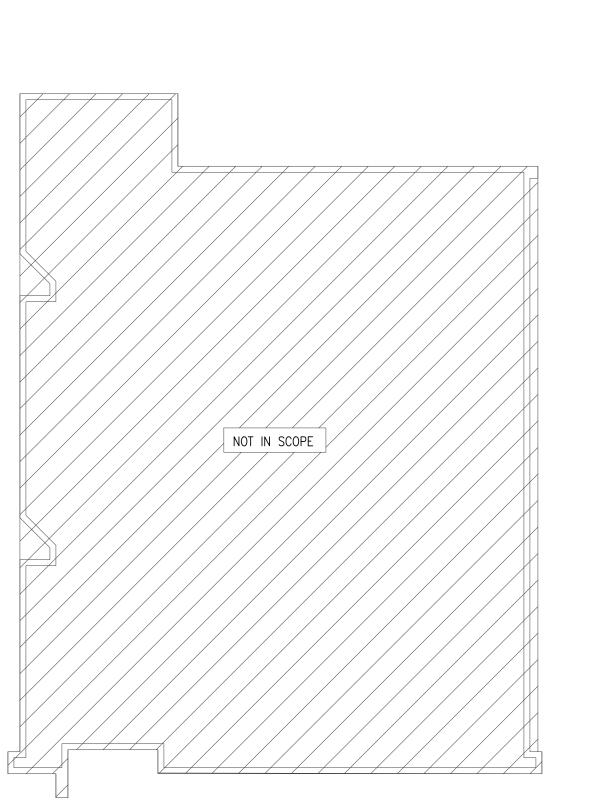
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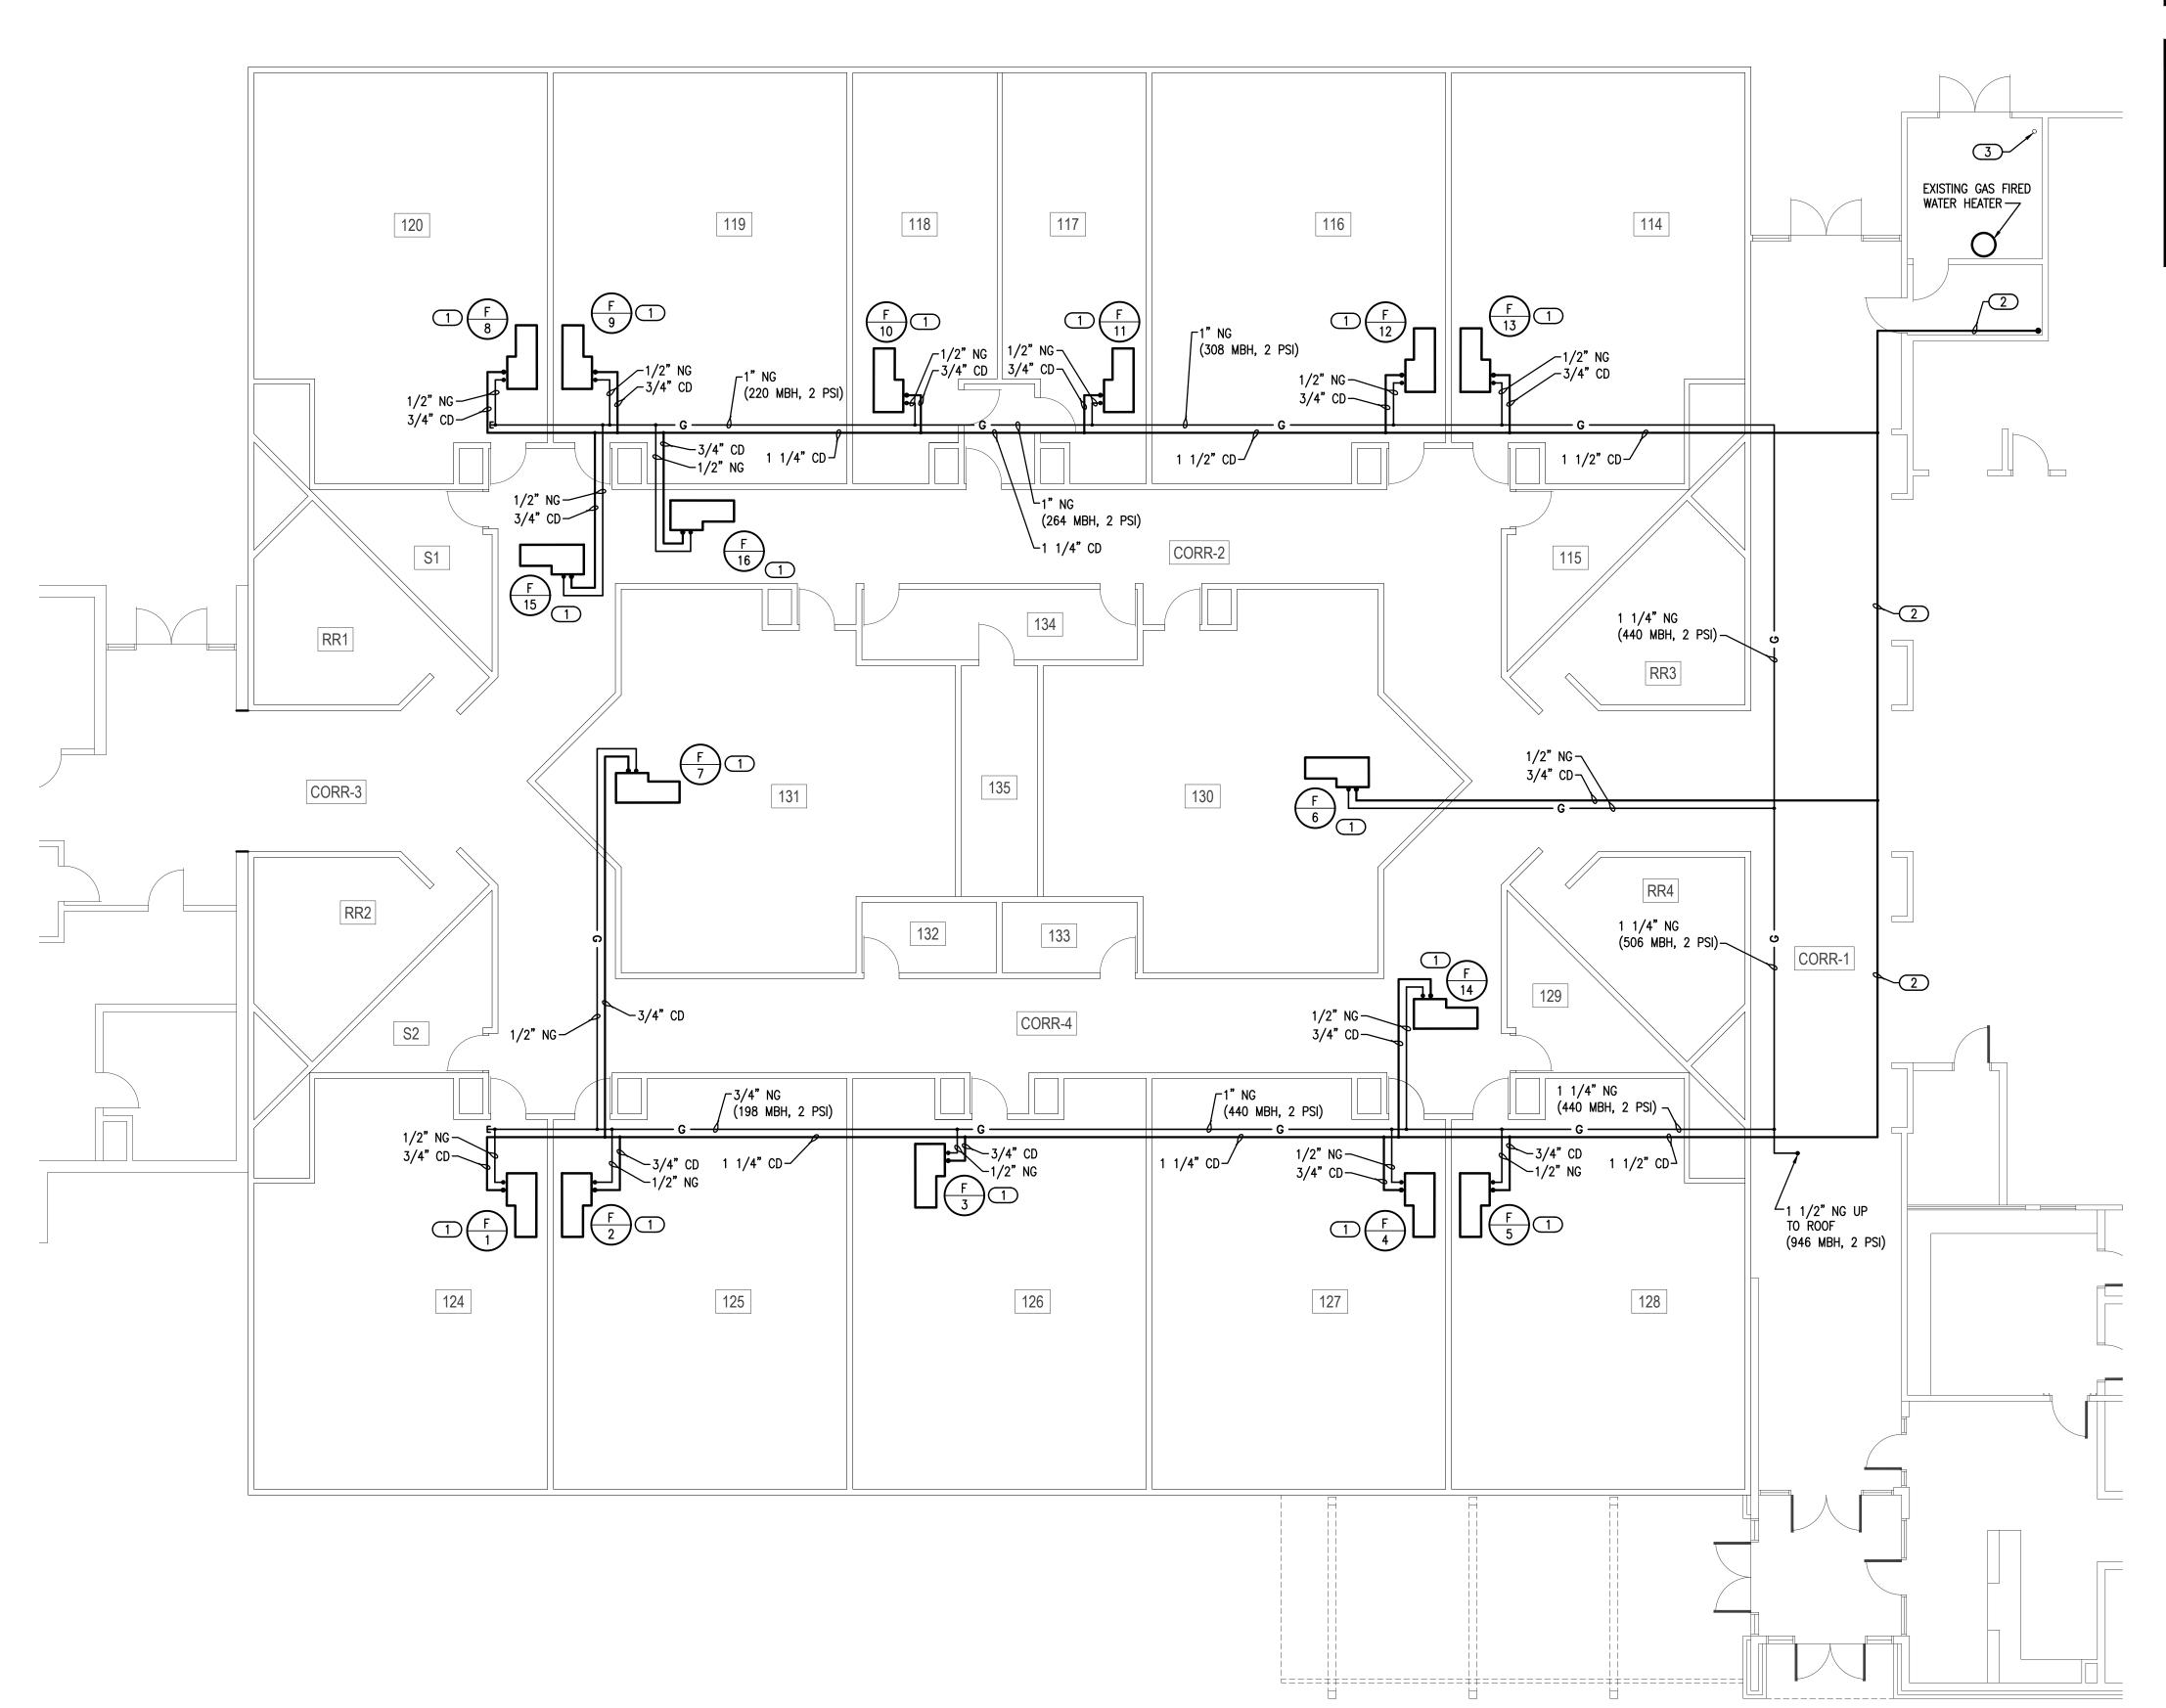

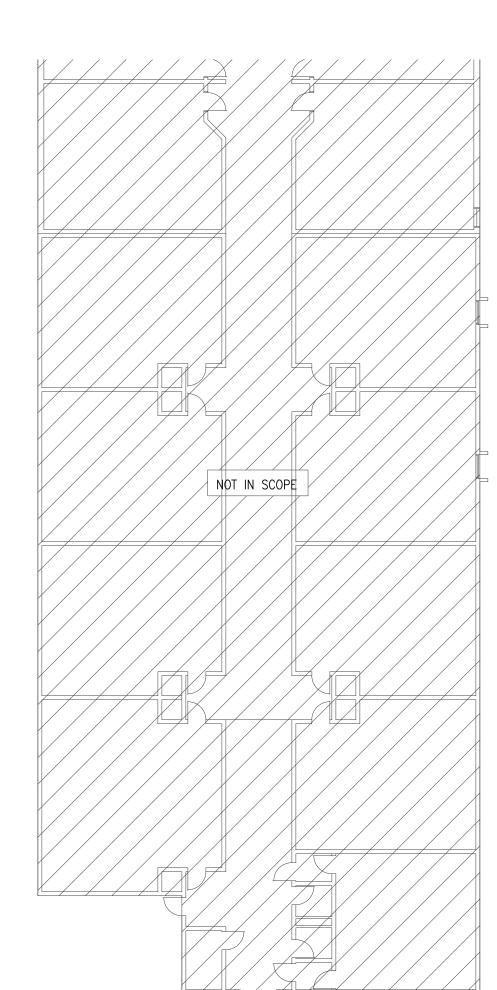
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GENERAL NOTES

- COORDINATE WORK WITH ALL OTHER TRADES ON SITE.
- 2. FIELD VERIFY EXISTING CONDITIONS PRIOR TO COMMENCING WORK.
- 3. SUPPORT PIPING PER LOCAL PLUMBING CODES.
- 4. INSULATE ALL CONDENSATE PIPING.

KEYED NOTES

- 1 INSTALL 1/2" NATURAL GAS (2 PSI) TO FURNACE WITH SHUTOFF VALVE, DRIP LEG, PRESSURE REGULATOR AND FINAL UNIT CONNECTION.
 ROUGH—IN AND COORDINATE FINAL CONNECTION WITH MC. SEE DETAIL
- 2 REMOVE EXISTING CONDENSATE DRAIN LINE AND REPLACE WITH NEW CD LINE. FIELD VERIFY ROUTING.
- REMOVE GAS PIPING FROM BOILER AND CAP PIPE AFTER BRANCH CONNECTION TO EXISTING WATER HEATER. EXISTING WATER HEATER GAS SERVICE TO REMAIN IN SERVICE.

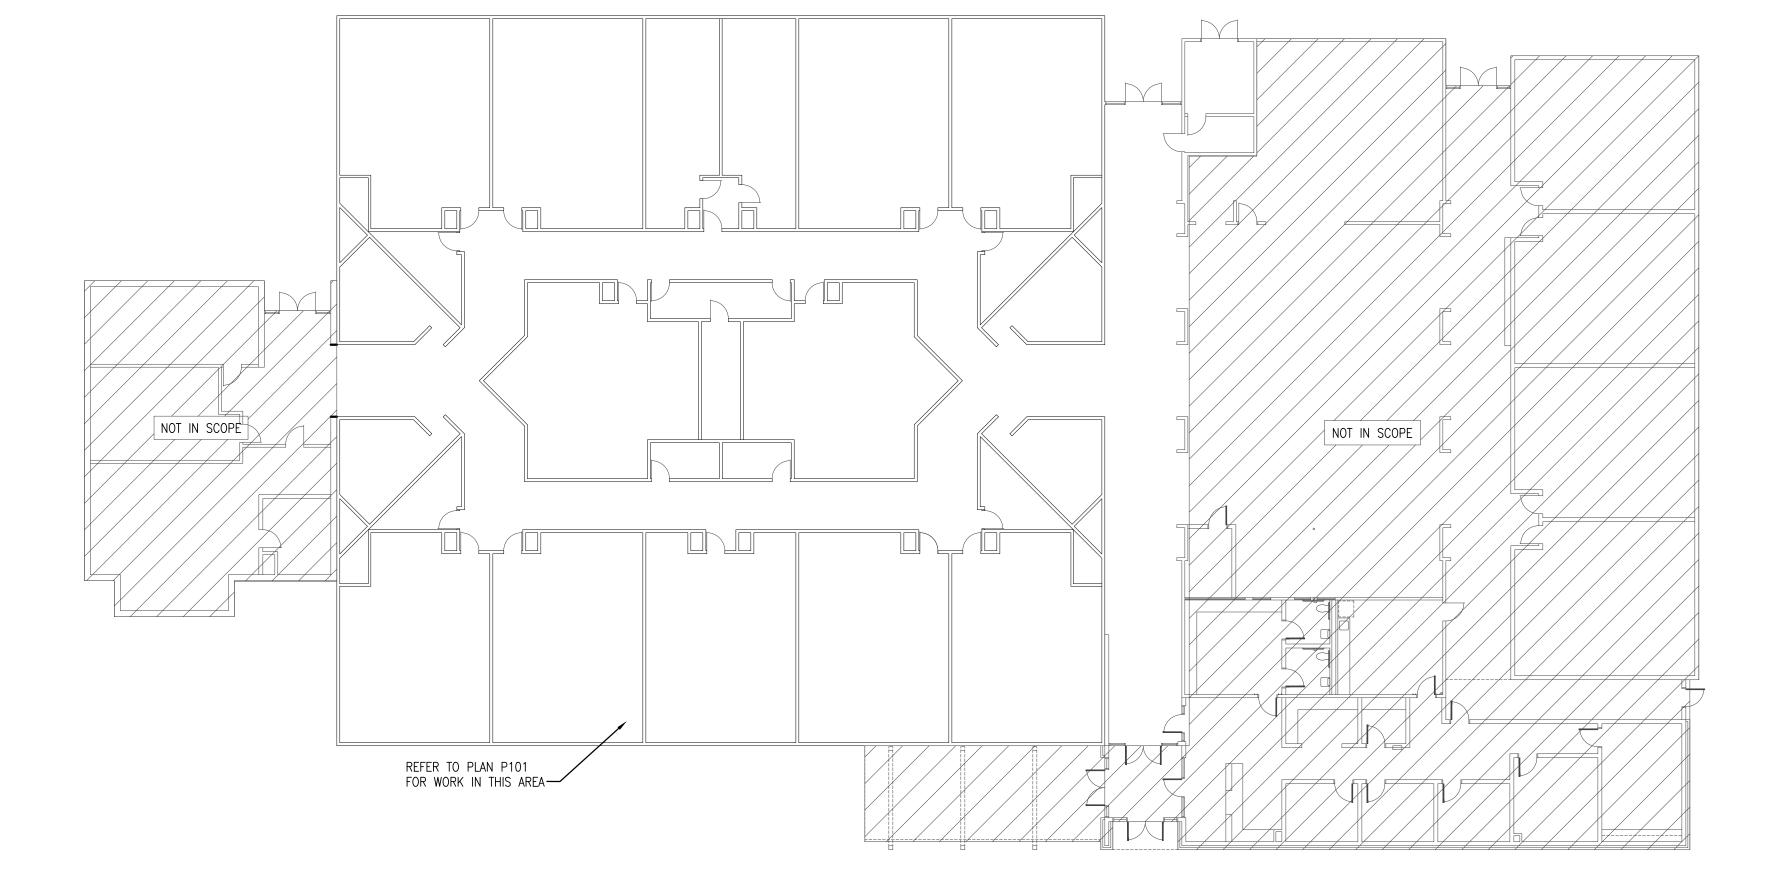

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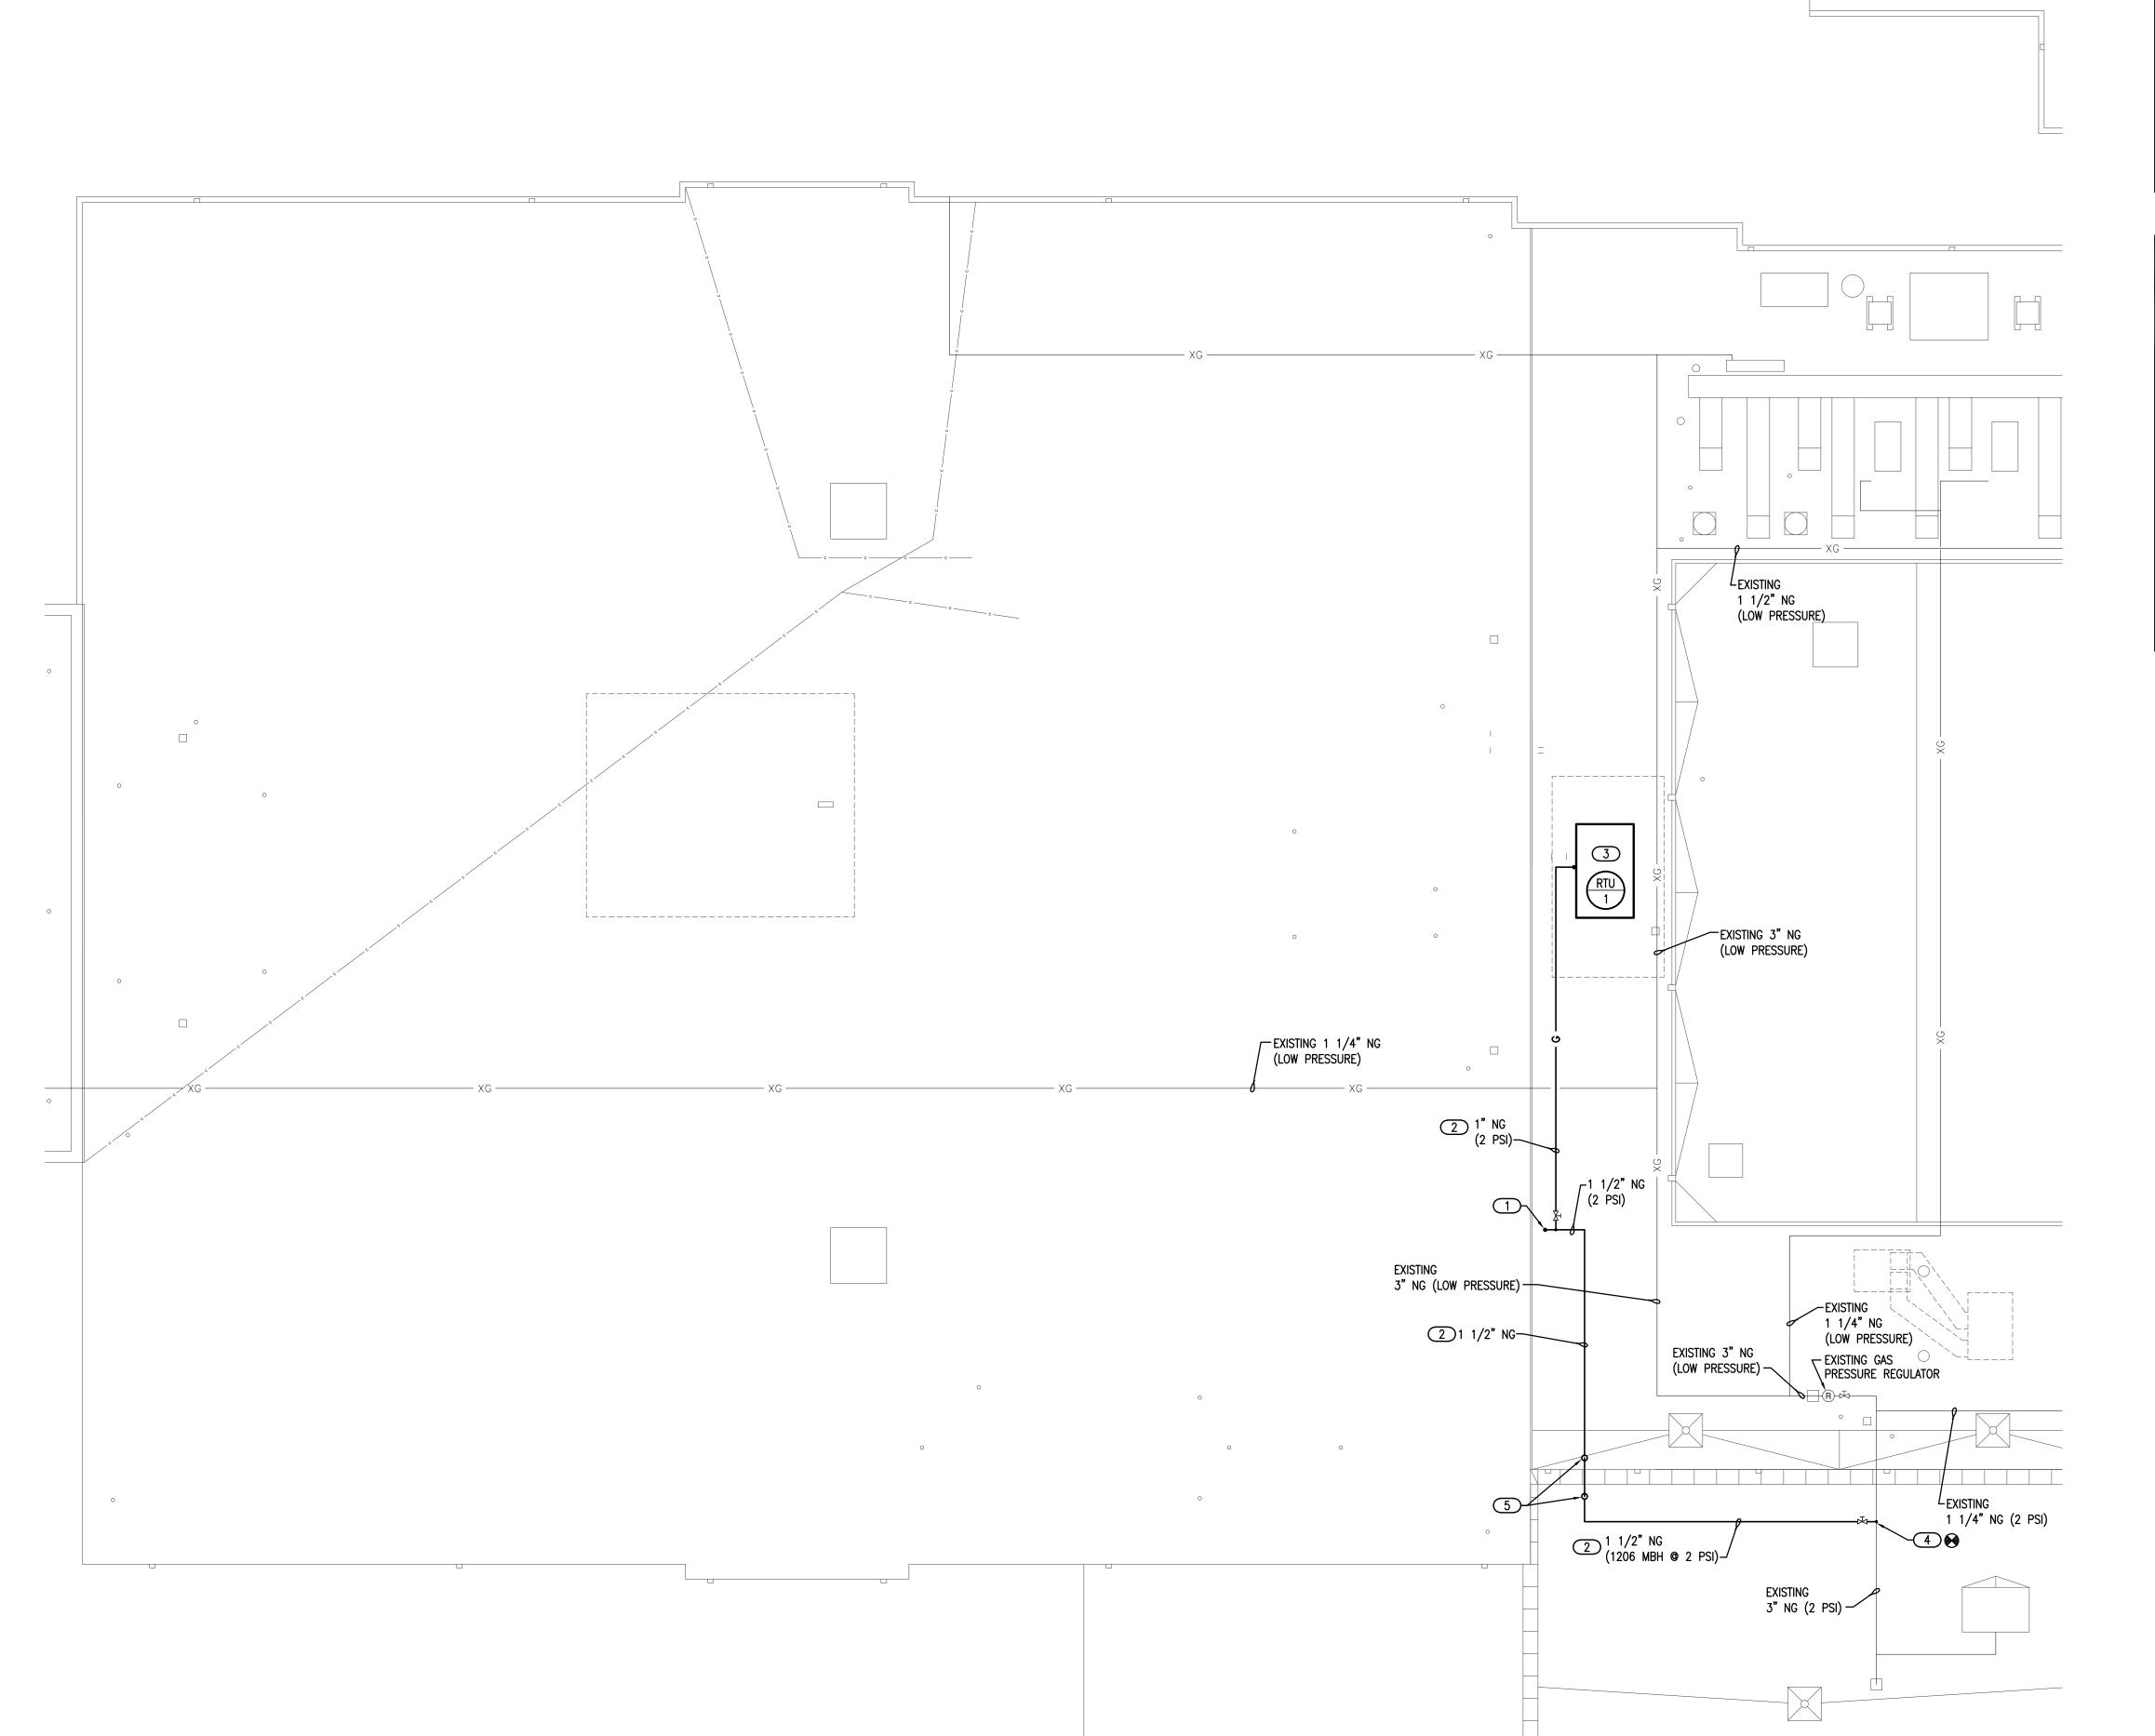
P101



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PLUMBING ROOF PLAN

SCALE: 1/8" = 1'-0"

GENERAL NOTES

. COORDINATE WORK WITH ALL TRADES ON SITE.

- FIELD VERIFY EXISTING CONDITIONS PRIOR TO COMMENCING WORK.
- 3. ALL ABOVE GRADE EXTERIOR NATURAL GAS PIPE SHALL BE CLEANED AND DEGREASED PRIOR TO BEING PRIMED THEN PAINTED YELLOW WITH WEATHER RESISTANT ZINC RICH PAINT.
- 4. PIPE IDENTIFICATION SHALL BE THE WORD "NATURAL GAS" IN BLACK LETTERS AT 5 FT INTERVALS USING PLASTIC PIPE MARKERS OR STENCILED PAINTED LETTERS.
- 5. ALL GAS PIPE SHALL COMPLY WITH IFGC. BRANCH LINES SHALL TAP OFF TOP OF GAS MAINS AND INSTALL SHUT—OFF VALVE ON BRANCH LINE.
- 6. MAINTAIN MINUMUM OF 10'-0" CLEAR BETWEEN EXHAUST AND INTAKE VENTS WITH MECHANICAL EQUIPMENT AND OTHER ROOF OPENINGS.

KEYED NOTES

- ROUTE NEW 1 1/2" NATURAL GAS LINE (2 PSI) DOWN THRU ROOF.
 PROVIDE NEW BOOT JACK AT ROOF PENETRATION AND SEAL WATERTIGHT.
 COORDINATE INSTALLATION WITH ROOFING CONTRACTOR. SEE PLAN P101
 FOR CONTINUATION.
- 2 ROUTE NATURAL GAS LINE (2 PSI) ON ROOF. PROVIDE MIRO INDUSTRIES MODEL 3—RAH—7 ROOF TOP SUPPORTS OR APPROVED EQUAL. INSTALL AT MAXIMUM OF 10'-0" APART (CENTER TO CENTER) ON ALL 1 1/4" NATURAL GAS PIPING OR LARGER. INSTALL AT 8'-0" APART ON 1" OR 3/4" NATURAL GAS PIPING. INSTALL AT 6'-0" APART ON 1/2" NATURAL GAS PIPING. REFER TO GENERAL NOTES FOR PAINTING GAS LINE. SEE PIPE SUPPORT DETAIL 1/P501.
- 3 INSTALL 1" NATURAL GAS (260 MBH, 2 PSI) LINE TO ROOFTOP UNIT. PROVIDE SHUTOFF VALVE, PRESSURE REGULATOR, DRIP LEG AND FINAL UNIT CONNECTION. ROUGH—IN AND COORDINATE FINAL CONNECTION WITH MC. SEE DETAIL 3/P501.
- CONNECT NEW 1 1/2" NATURAL GAS LINE (2 PSI) INTO TOP OF EXISTING 3" NATURAL GAS LINE @ 2 PSI. INSTALL GAS BALL VALVE IN NEW 1 1/2" GAS LINE. FIELD VERIFY CONNECTION POINT.
- 5 ROUTE NATURAL GAS LINE OVER ROOF PARAPET. FIELD VERIFY ROUTING.



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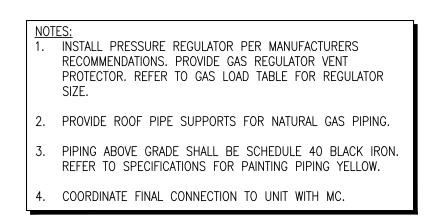
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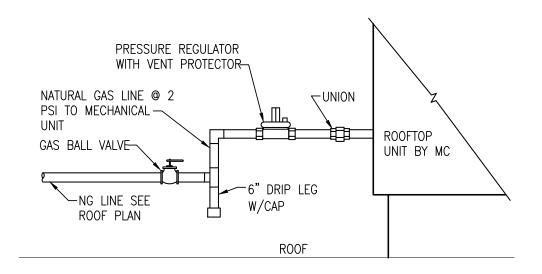
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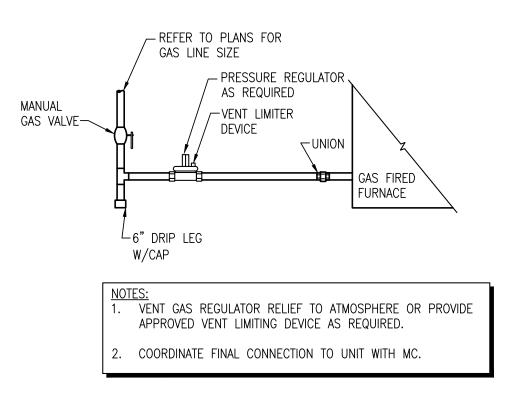
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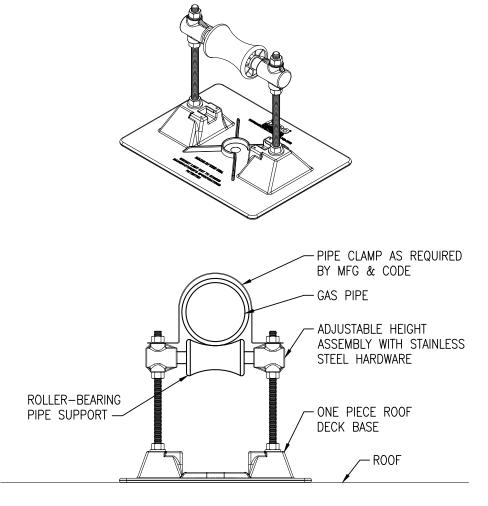




3 ROOFTOP UNIT GAS CONNECTION DETAIL
NOT TO SCALE



2 FURNACE GAS CONNECTION DETAIL
NOT TO SCALE



1 ROOF PIPE SUPPORT DETAIL

NOT TO SCALE



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