
MATCHLINE AREA A MATCHLINE AREA B

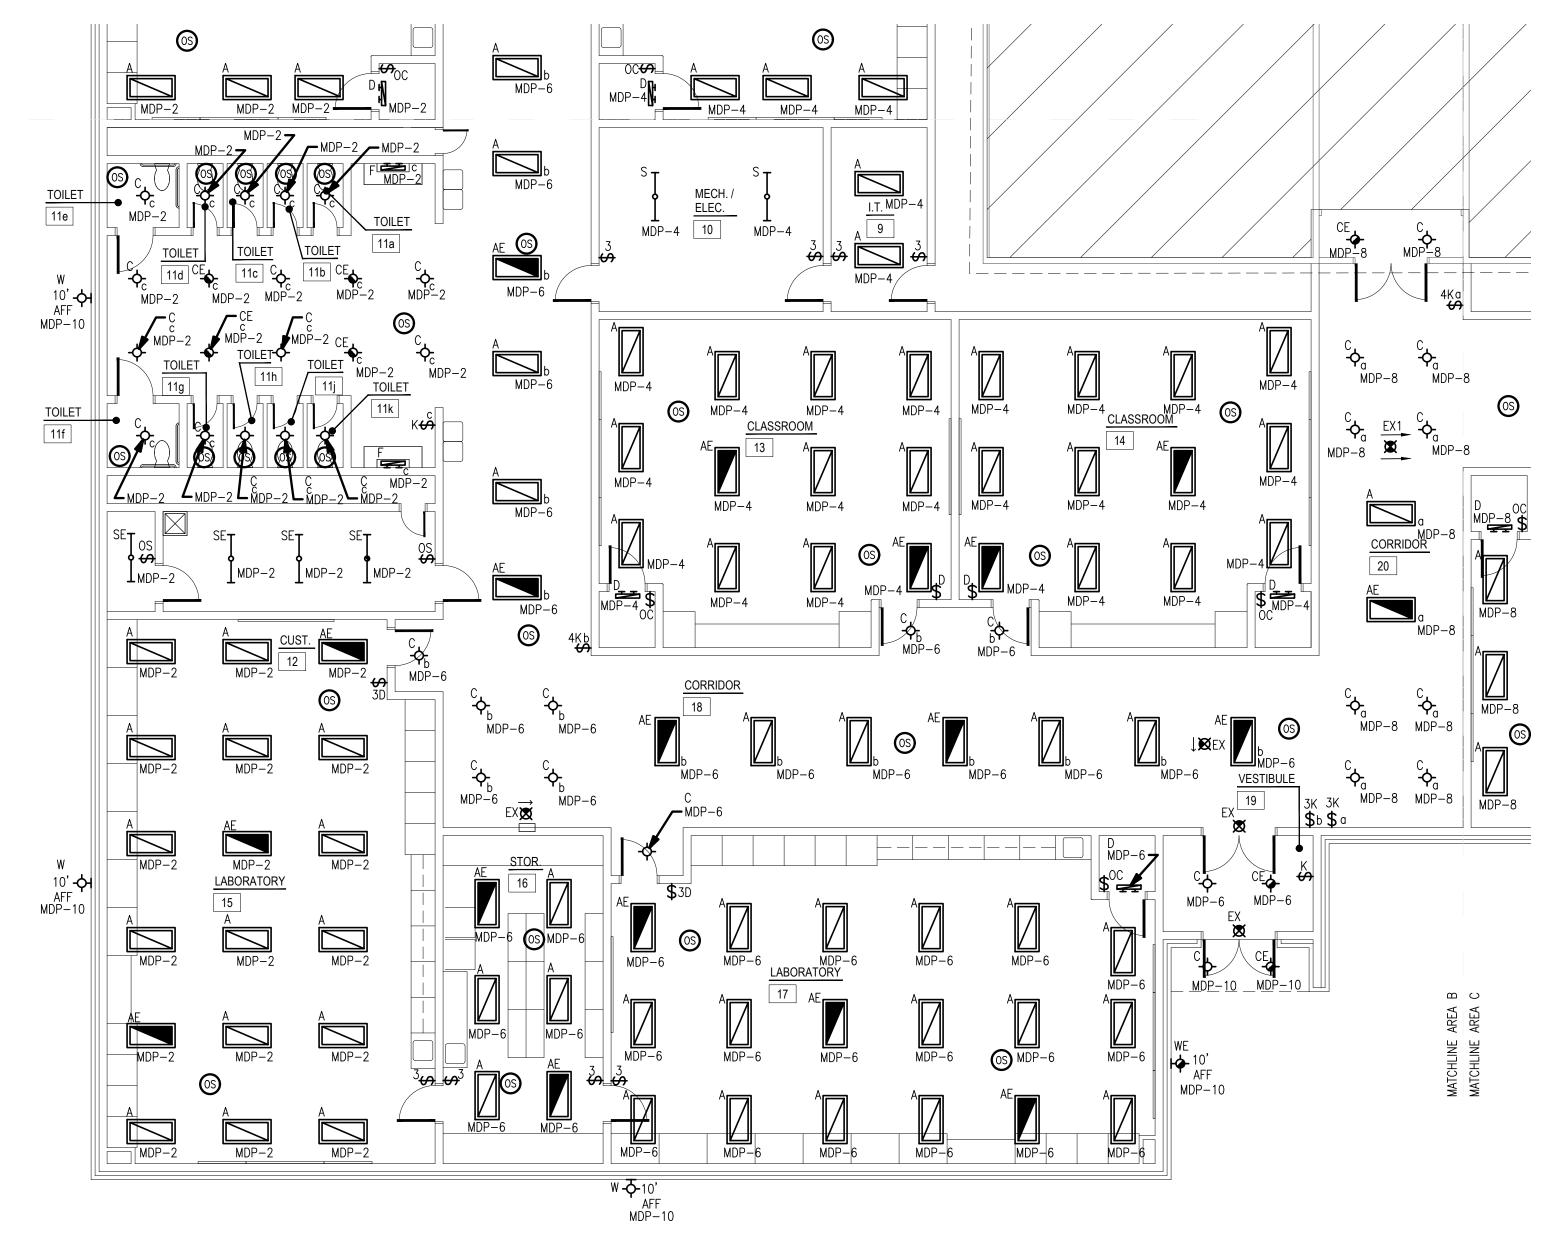

ELECTRICAL LIGHTING PLAN - AREA BSCALE: 1/8" = 1'-0"



LIGHTING GENERAL NOTES

- OCCUPANCY SENSOR LOCATIONS SHOWN ARE FOR DESIGN INTENT ONLY. LOCATE OCCUPANCY SENSORS PER MANUFACTURER'S WRITTEN INSTALLATION INSTRUCTIONS.
- COORDINATE EXACT LOCATIONS AND MOUNTING HEIGHTS OF LIGHT FIXTURES WITH HVAC EQUIPMENT AND OTHER DEVICES/EQUIPMENT.
- COORDINATE LIGHT SWITCHES WITH THERMOSTATS AND OTHER WALL MOUNTED
- PROVIDE RELAY CONTACTOR FOR EXTERIOR LIGHTING. RELAY SHALL INTERLOCK WITH THE NEAREST EXISTING LIGHTING CIRCUIT SUCH THAT THE EXISTING LIGHTING CONTROL SHALL CONTROL THE NEW EXTERIOR LIGHTING.





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CEDAR CREEK

KFC ENGINEERING

STRUCTURAL

SALAS O'BRIEN


MECHANICAL / ELECTRICAL



checked by JULY 2023

MOORE PUBLIC SCHOOLS **BOARD OF EDUCATION** MOORE, OKLAHOMA



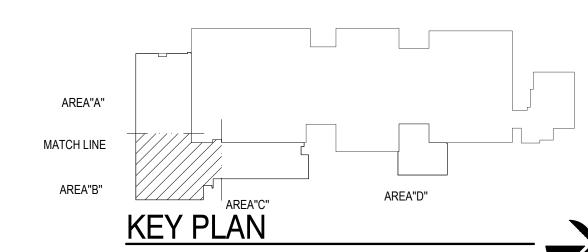

CLASSROOM ADDITION HIGHLAND WEST JUNIOR HIGH SCHOOL

sheet no:

E102



Salas O'Brien Project Number: 2023-02792-00

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