

**MOORE PUBLIC SCHOOLS -
CENTRAL JUNIOR HIGH SCHOOL –
STEM CLASSROOM ADDITION**

Moore Public Schools - Moore, Oklahoma
AGP - Moore, Oklahoma


CONSTRUCTION BULLETIN NO. 4

September 30, 2025

1. ADDED DETAIL CONCERNING EXISTING OVERHEAD DETAIL AT DOORS 41 & 42.
2. REVISED CIVIL SHEETS C2.00, C3.00, C4.01, & F1.00 INDICATING WIDENING OF CONNECTION BETWEEN CENTRAL ELEMENTARY DROP-OFF LANE AND NEW PARKING LOT AS REQUESTED BY THE CITY OF MOORE.
3. REVISED SHEETS S202 & S302 INDICATING REVISIONS TO DOORS 40 & 43.
4. ADDED CONTROL JOINTS TO WEST ELEVATION WALL AS PER REVISED DETAIL 1A202.

REFER TO ATTACHMENTS.

END OF CONSTRUCTION BULLETIN NO. 4

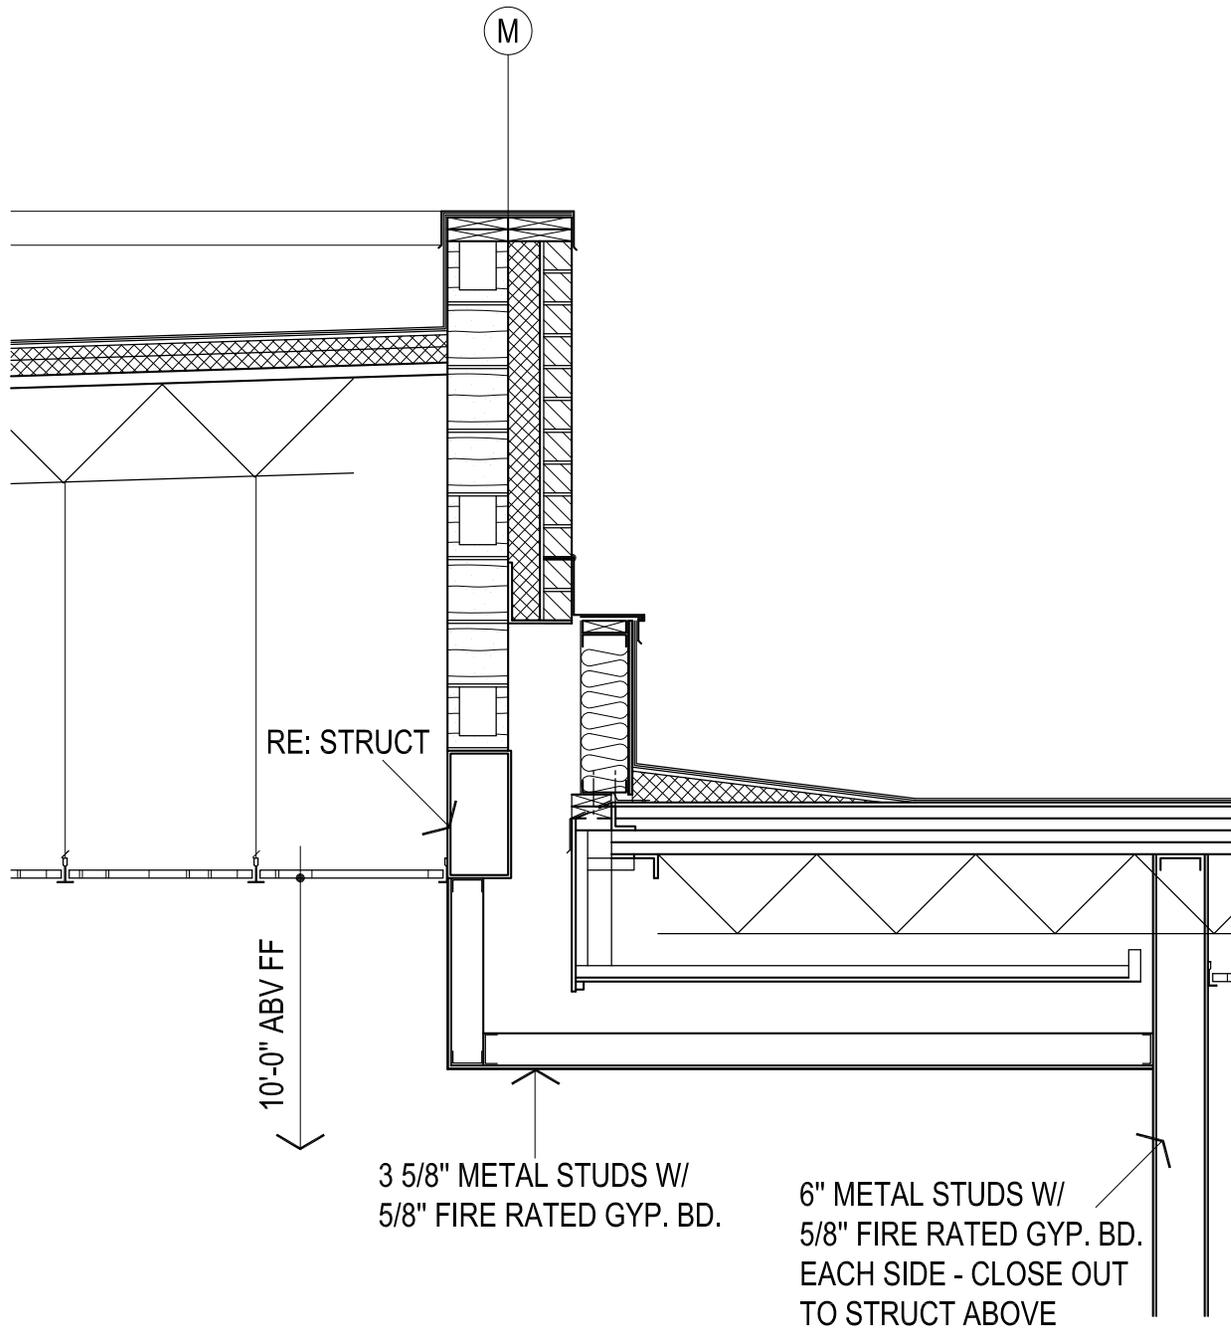

SECTION @ DOOR 41 & 42

1/2" = 1'-0"


CENTRAL JR HIGH CB-4

LEGEND

---	EXISTING 1' CONTOUR	---	EXISTING 5' CONTOUR
---	PROPOSED 1' CONTOUR	---	PROPOSED 5' CONTOUR
---	BOUNDARY LINE	---	RIGHT OF WAY LINE
---	EASEMENT LINE	---	EXISTING CURB AND GUTTER
---	PROPOSED CURB AND GUTTER	---	PROPOSED FIRE LANE STRIPING
---	OVERHEAD ELECTRIC LINE	---	UNDERGROUND ELECTRIC LINE
---	GAS LINE	---	UNDERGROUND TELEPHONE LINE
---	UGT	---	UNDERGROUND FIBER OPTIC LINE
---	FO	---	SANITARY SEWER LINE
---	SS	---	WATERLINE
---	W	---	RETAINING WALL
---	SCREEN WALL	---	WIRE FENCE
---	CHAIN LINK FENCE	---	BENCHMARK
---	PROP. FIRE HYDRANT	---	PROP. WHEEL STOP
---	PROP. WATER VALVE	---	PROP. FES
---	PROP. WATER METER	---	PROP. HC RAMP
---	PROP. ELECT. METER	---	PROP. POWER POLE
---	PROP. LIGHT POLE	---	PROP. SS MANHOLE
---	PROP. BOLLARD	---	PROP. GAS METER
---	PROP. TRANSFORMER	---	PROP. SIGN
---	PROP. PARKING COUNT	---	PROP. FIRE ROUTE SIGN
---	PROP. INLETS (SEE GRADING PLAN FOR TYPE)	---	
---	VERTICAL SEPARATION REQUIREMENT	---	

SITE NOTES

- A. CONTRACTOR SHALL REFER TO THE CONSTRUCTION DOCUMENTS INCLUDING BUT NOT LIMITED TO THE WRITTEN SPECIFICATIONS, CONSTRUCTION DRAWINGS, STORM WATER POLLUTION PLAN, AND GEOTECHNICAL REPORT.
- B. ALL CONSTRUCTION SHALL BE IN STRICT ACCORDANCE WITH THE OWNERS DESIGN GUIDELINES AND SPECIFICATIONS, AND WHERE APPLICABLE SHALL MEET THE REQUIREMENTS OF THE GOVERNING/PERMITTING AUTHORITY HAVING JURISDICTION.
- C. CONTRACTOR IS RESPONSIBLE FOR THEIR OWN HORIZONTAL AND VERTICAL CONTROL, REFERENCE POINTS AND CONSTRUCTION STAKING AS INCIDENTAL TO THE PROJECT.
- D. THE CONTRACTOR SHALL FIELD VERIFY EXISTING ELEVATIONS/PROPERTY LINES/UTILITIES/DRAINAGE PRIOR TO CONSTRUCTION START.
- E. ALL WORK NOT CLASSIFIED AS A CONTRACT PAY ITEM SHALL BE CONSIDERED AS INCIDENTAL AND THE COST THEREOF SHALL BE INCLUDED IN THE UNIT PRICE BID FOR ITEMS WHICH ARE CLASSIFIED FOR PAYMENT.
- F. CONTRACTOR SHALL REFER TO THE ARCHITECTURAL AND MEP PLANS AND SPECIFICATIONS BEING A PART OF THE CONSTRUCTION DOCUMENTS FOR THE EXACT LOCATIONS AND DIMENSIONS OF ENTRY, EXIT PORCHES, PRECISE BUILDING DIMENSIONS, EXACT BUILDING UTILITY ENTRANCE, AND DOWNSPOUT LOCATIONS/SPECIFICATIONS/DETAILS.
- G. ALL DIMENSIONS SHOWN ARE TO THE FACE OF CURB (FC) UNLESS OTHERWISE NOTED.
- H. PARKING LOT STRIPING SHALL BE 4" WIDE AND WHITE IN COLOR. HANDICAP PARKING STALLS STRIPING AND SIGNAGE SHALL BE IN STRICT ACCORDANCE WITH FEDERAL, STATE, AND LOCAL REQUIREMENTS.
- I. UNLESS OTHERWISE NOTED ALL RADII SHALL BE 3'.
- J. BUILDING DIMENSIONS ARE TO OUTSIDE OF MASONRY, UNLESS OTHERWISE SHOWN.
- K. CONTRACTOR SHALL REFER TO THE ARCHITECTURAL PLANS AND SPECIFICATIONS FOR ACTUAL LOCATION AND DETAILS OF ALL UTILITY ENTRANCES. CONTRACTOR SHALL COORDINATE INSTALLATION OF UTILITIES IN SUCH A MANNER AS TO AVOID CONFLICTS AND ASSURE PROPER DEPTHS ARE ACHIEVED, AS WELL AS COORDINATED WITH ANY UTILITY COMPANIES FOR APPROVED LOCATIONS AND SCHEDULING OF TIE-INS/CONNECTIONS TO THEIR FACILITIES.
- L. REFER TO ARCHITECTURE PLANS FOR SITE LIGHTING AND ELECTRICAL CONDUIT PLANS. POLE LOCATIONS ARE SHOWN ON THIS SHEET FOR REFERENCE ONLY. IT IS THE CONTRACTOR'S RESPONSIBILITY TO IDENTIFY AND ADJUST ANY CONSTRUCTED CONFLICTS WITH UNDERGROUND UTILITIES, SIDEWALKS, ETC.
- M. CHECK ARCHITECTURAL PLANS FOR EXACT DOWNSPOUT LOCATIONS.
- N. CONTRACTOR SHALL REFER TO LANDSCAPE AND IRRIGATION PLAN FOR LOCATION AND CONSTRUCTION DETAILS OF LANDSCAPING AND IRRIGATION.

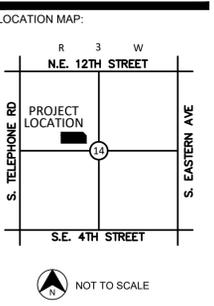

PROJECT:
CENTRAL JUNIOR HIGH CLASSROOM ADDITION
 400 N. BROADWAY ST. MOORE, OKLAHOMA

PROJECT NUMBER: 25031
 DRAWING DATE: 06.02.25
 ISSUE DATE: 06.02.25



SUBMITTAL:
PERMIT SET

REVISIONS:



NO.	DATE	DESCRIPTION
1	08.13.25	ADDENDUM 03
2	09.29.25	CB-4

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DRAWING TITLE:

SITE PLAN


SHEET:
C2.00

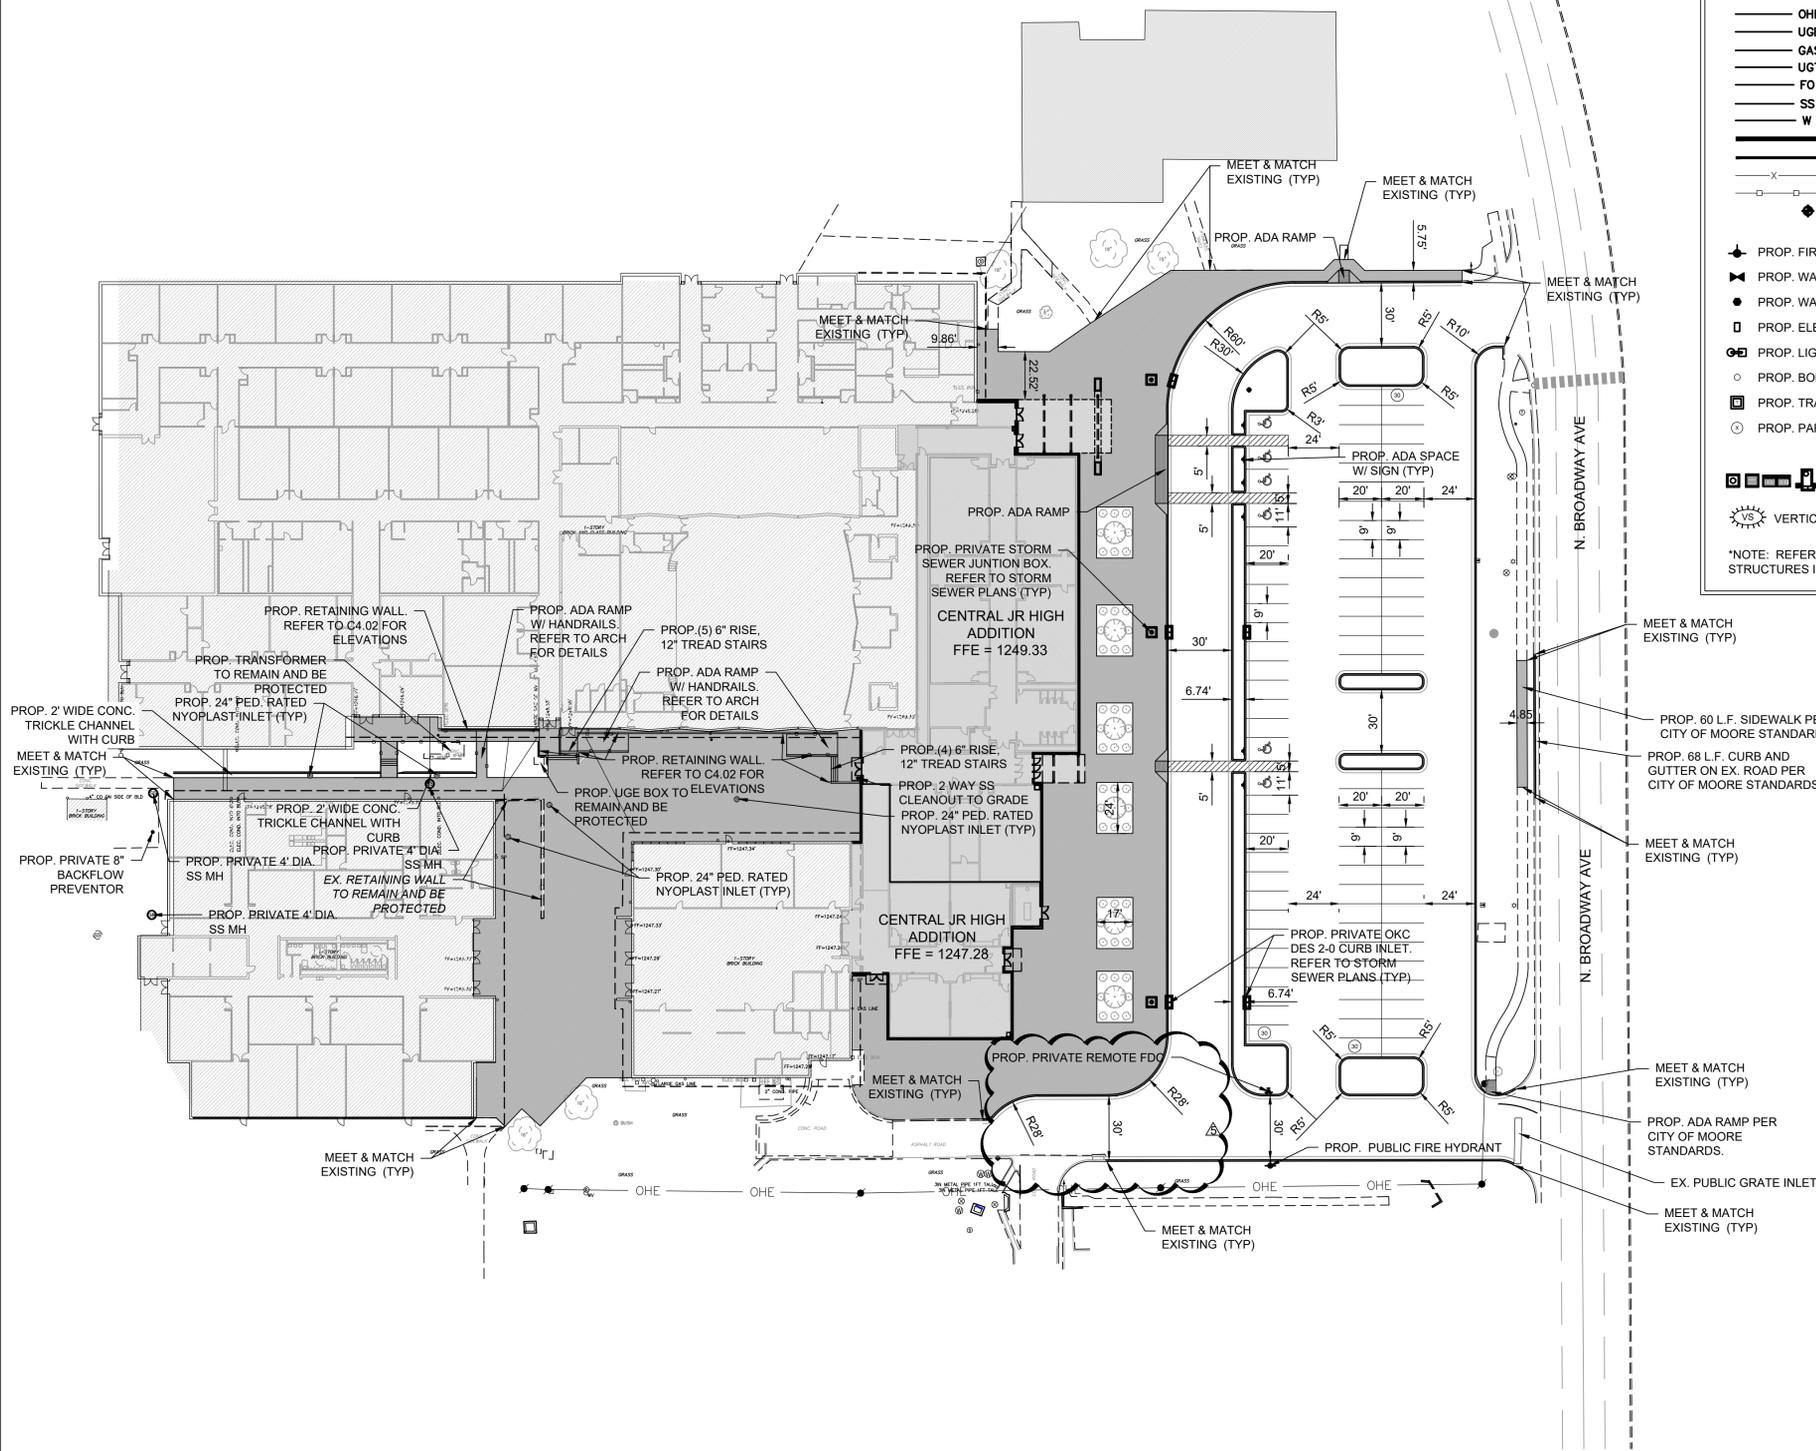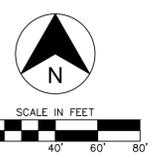

NOTE: CONTRACTOR IS RESPONSIBLE FOR ENSURING THAT ALL PROPOSED WORK MEETS ADA REQUIREMENTS. REFER TO www.access-board.gov/ada-aba/ada-standards-doj.cfm

NOTE: CONTRACTOR SHALL CONSTRUCT AND INSTALL WHEEL STOPS, SIGNS, AND ADA RAMP AT ALL HANDICAP SPACES.

LOCATION MAP:

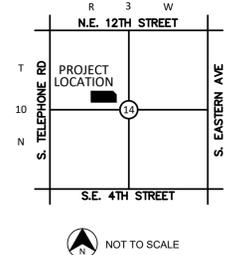

PROJECT:

CENTRAL JUNIOR HIGH CLASSROOM ADDITION

400 N. BROADWAY ST. MOORE, OKLAHOMA

PROJECT NUMBER: 25031
 DRAWING DATE: 06.02.25
 ISSUE DATE: 06.02.25

SEAL:



SUBMITTAL:

PERMIT SET

REVISIONS:

▲	07.01.25	ADDENDUM 01
▲	08.13.25	ADDENDUM 03
▲	09.29.25	CB-4

MARK DATE DESCRIPTION

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DRAWING TITLE:

PAVING PLAN





SHEET:

C3.00






PAVING LEGEND


- SIDEWALK PAVEMENT
- HEAVY DUTY DUMPSTER CONCRETE PAVEMENT
- HEAVY DUTY ASPHALT PAVEMENT
- LIGHT DUTY ASPHALT PAVEMENT
- ASPHALT TO CONCRETE THICKENED EDGE
- OMIT GUTTER VALLEY

NOTE: PAVING SECTIONS SHOWN ON CIVIL PLANS ARE FOR INFORMATIONAL PURPOSES ONLY. GEOTECHNICAL REPORT AND RECOMMENDATIONS SHALL GOVERN. CONTRACTOR SHALL CONTACT ENGINEER IF THERE IS A CONFLICT BETWEEN GEOTECHNICAL RECOMMENDATIONS AND CIVIL PLANS.

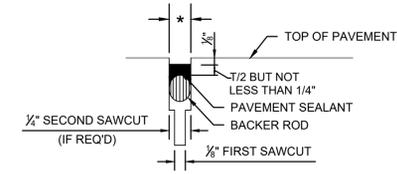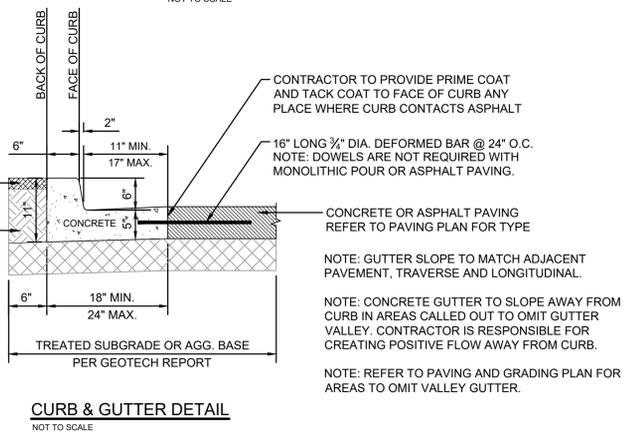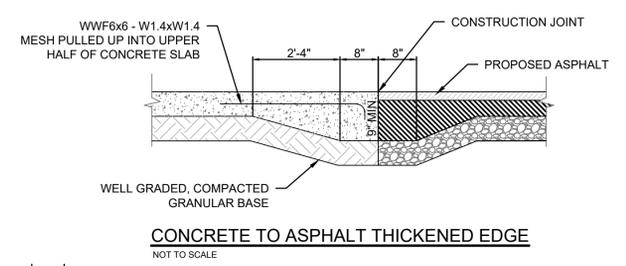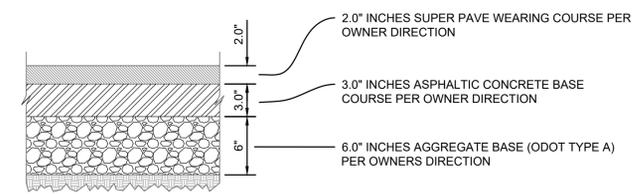

* = WAIT AS LONG AS FEASIBLE TO SEAL JOINTS TO ALLOW CONCRETE SHRINKAGE TO OCCUR. IF REQUIRED, RE-SAW JOINT IMMEDIATELY PRIOR TO INSTALLING SEALANT TO ACHIEVE A 1/2" JOINT WIDTH. ENSURE JOINT IS CLEAN, DRY AND SIDE PREPARED PER MFR'S RECOMMENDATIONS.

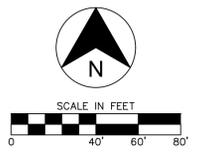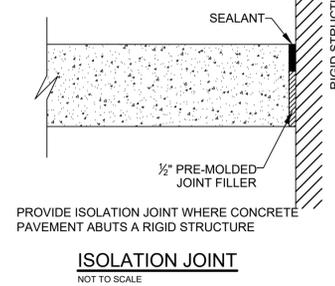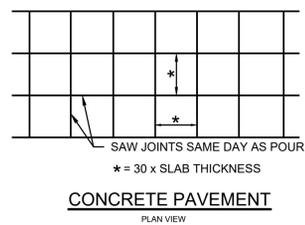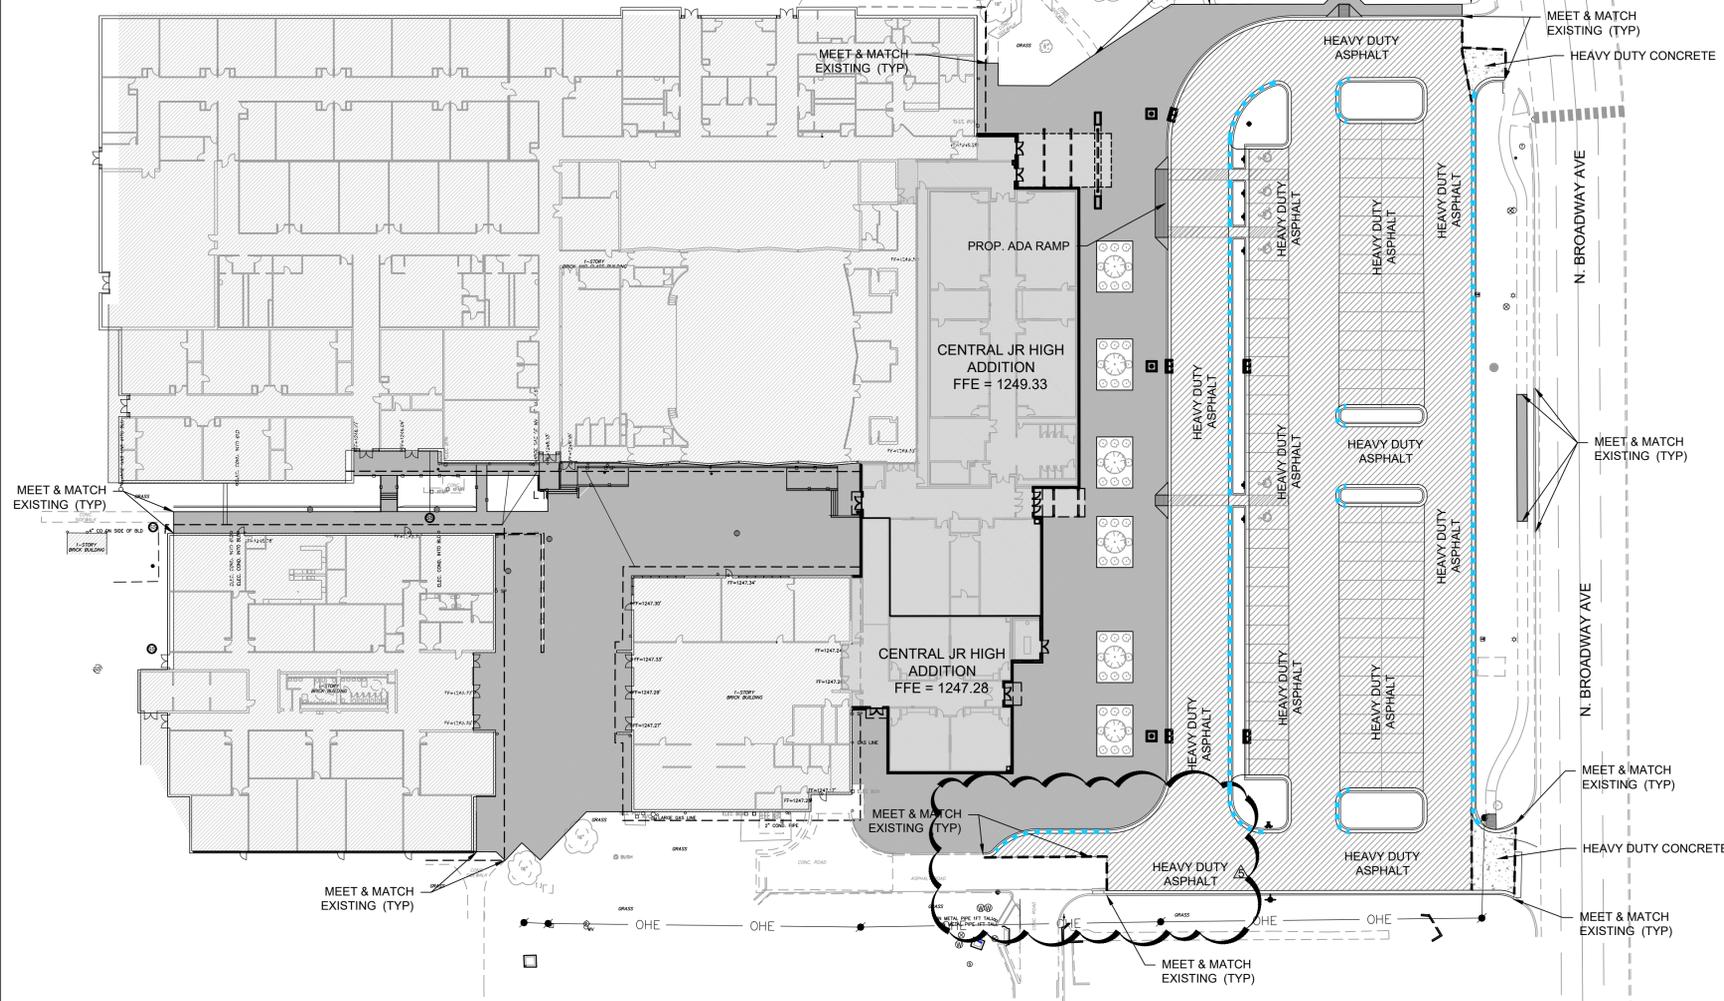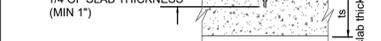

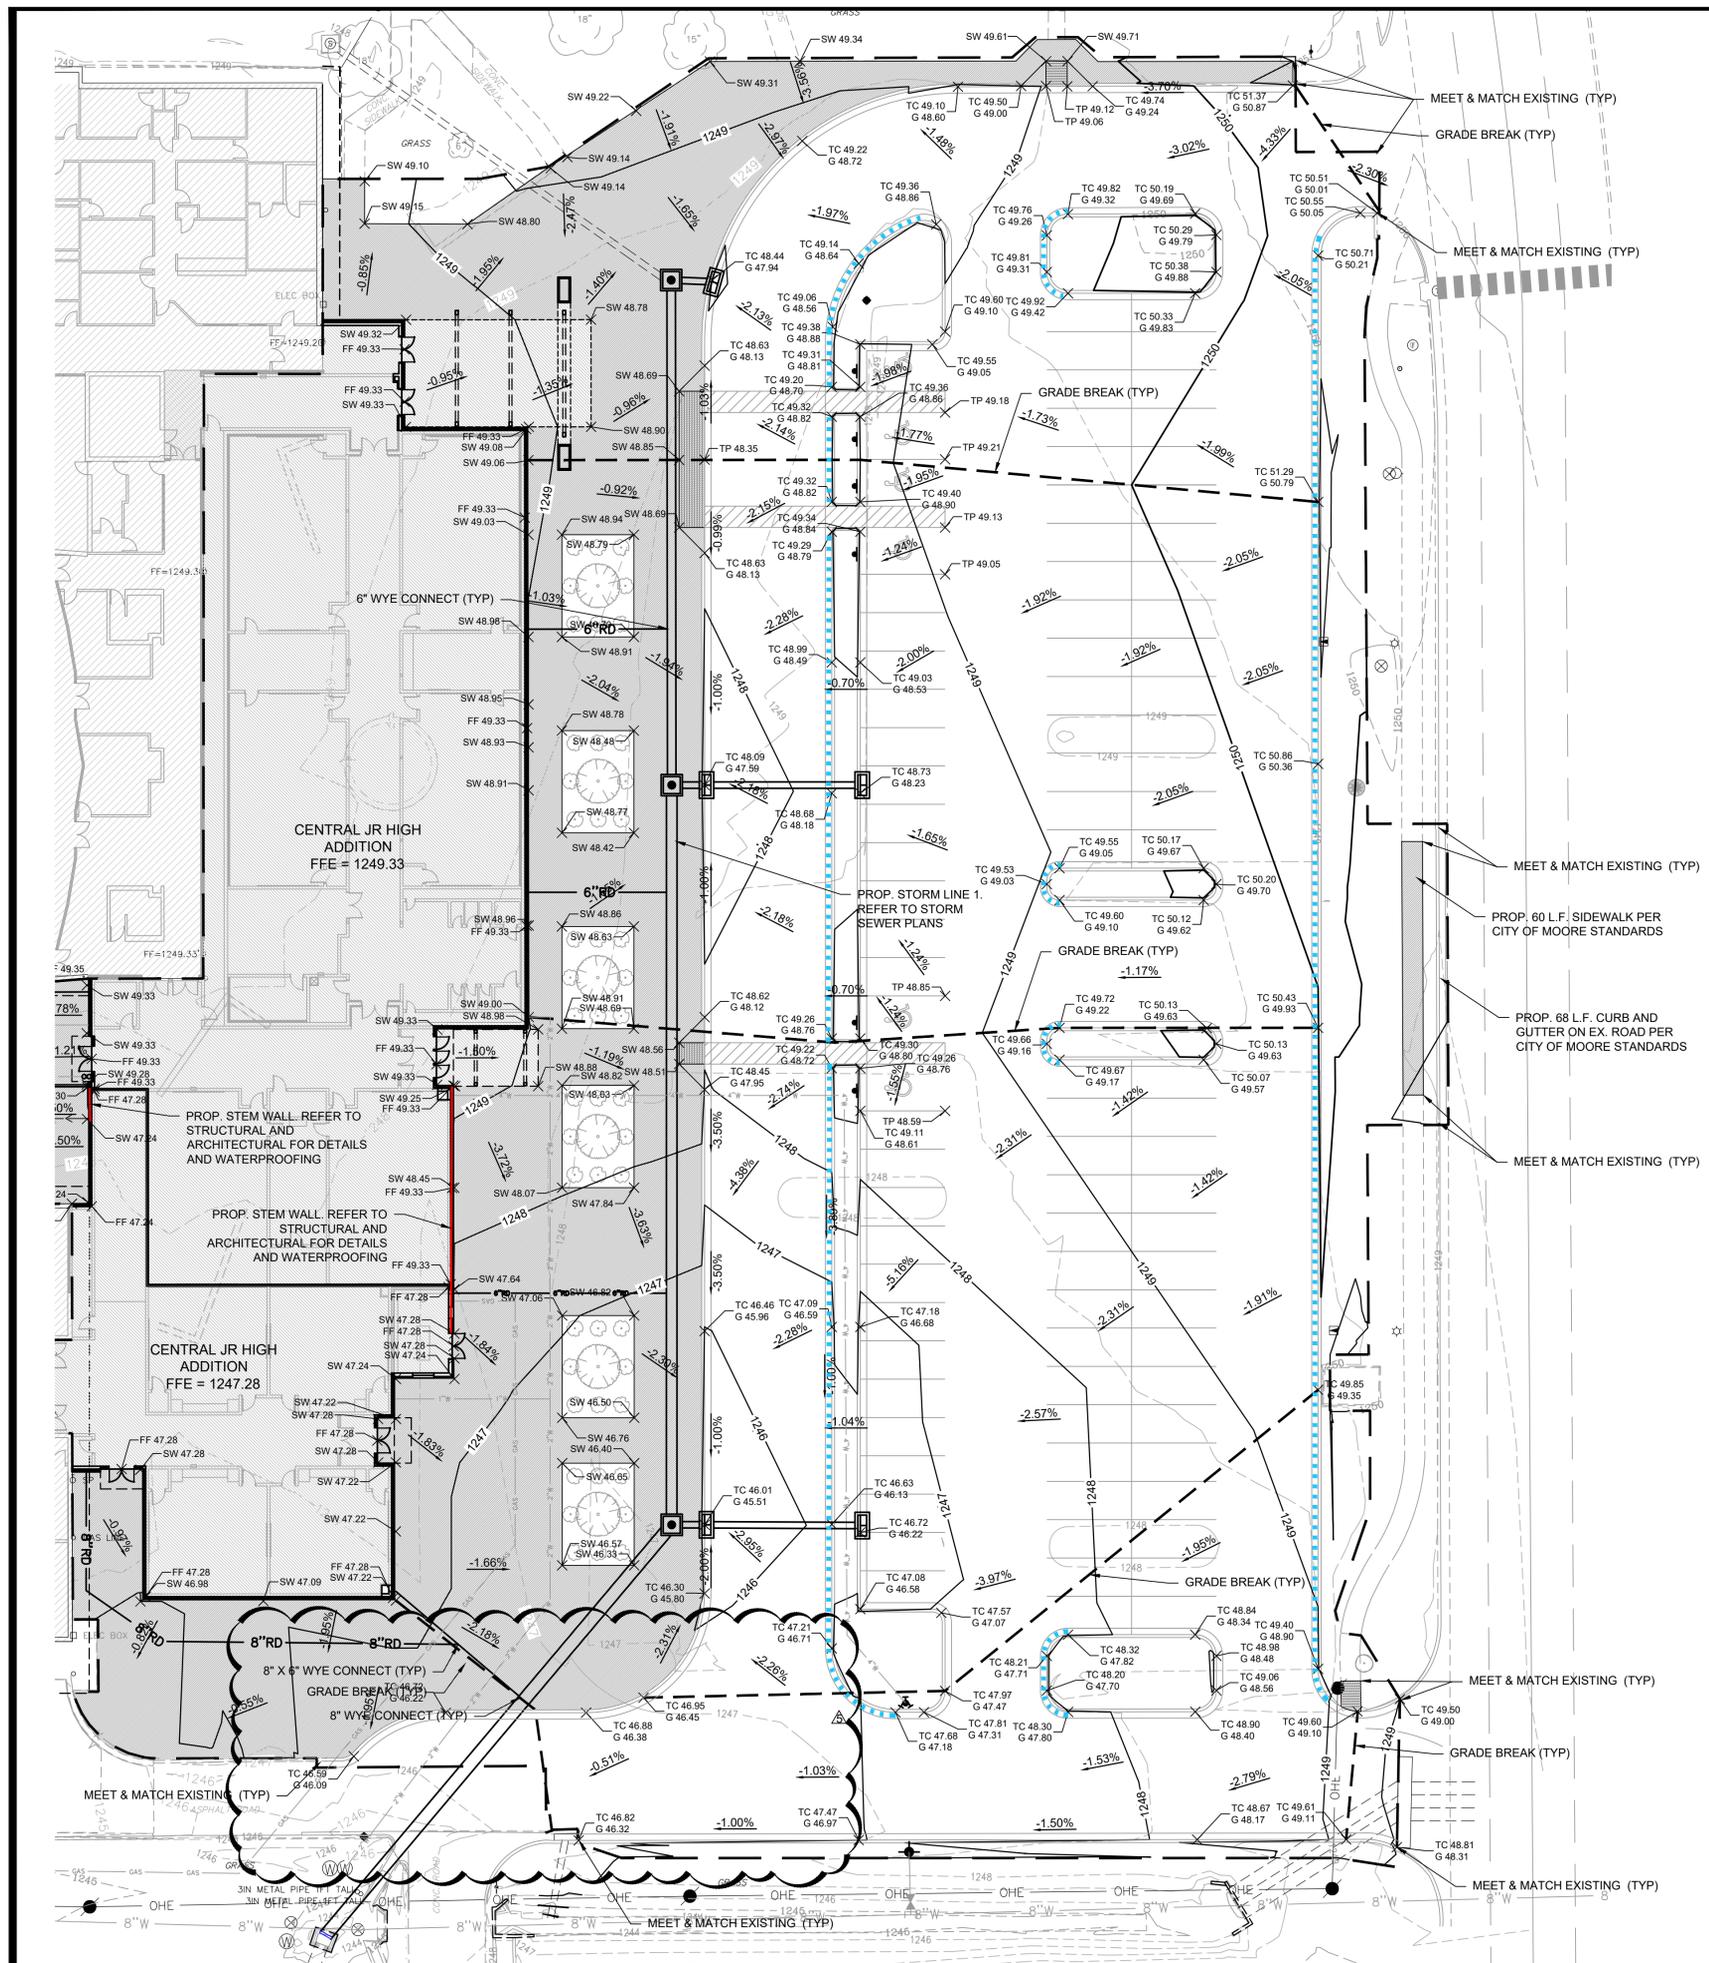

LEGEND

	EXISTING 1' CONTOUR		EXISTING 5' CONTOUR
	PROPOSED 1' CONTOUR		PROPOSED 5' CONTOUR
	BOUNDARY LINE		RIGHT OF WAY LINE
	EASEMENT LINE		EXISTING CURB AND GUTTER
	PROPOSED CURB AND GUTTER		PROPOSED FIRE LANE STRIPING
	OVERHEAD ELECTRIC LINE		UNDERGROUND ELECTRIC LINE
	GAS LINE		UNDERGROUND TELEPHONE LINE
	UGT		UNDERGROUND FIBER OPTIC LINE
	FO		SANITARY SEWER LINE
	SS		WATERLINE
	W		RETAINING WALL
			SCREEN WALL
			WIRE FENCE
			CHAIN LINK FENCE
			BENCHMARK
			OMIT GUTTER VALLEY

	PROP. FIRE HYDRANT		PROP. WHEEL STOP
	PROP. WATER VALVE		PROP. FES
	PROP. WATER METER		PROP. HC RAMP
	PROP. ELECT. METER		PROP. POWER POLE
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	PROP. BOLLARD		PROP. GAS METER
	PROP. TRANSFORMER		PROP. SIGN
	PROP. PARKING COUNT		PROP. FIRE ROUTE SIGN

PROP. INLETS (SEE GRADING PLAN FOR TYPE)

VERTICAL SEPARATION REQUIREMENT


*NOTE: REFER TO SURVEYING LEGEND FOR EXISTING STRUCTURES IDENTIFICATION

- ### GRADING NOTES
- CONTRACTOR SHALL REFER TO THE SITE SPECIFIC GEOTECHNICAL REPORT FOR EXISTING SOIL CONDITIONS, CONSIDERATIONS, AND RECOMMENDATIONS.
 - CONTRACTOR SHALL REFER TO THE CONSTRUCTION DOCUMENTS INCLUDING BUT NOT LIMITED TO THE WRITTEN SPECIFICATIONS, CONSTRUCTION DRAWINGS, STORM WATER POLLUTION PLAN, AND GEOTECHNICAL REPORT.
 - CONTRACTOR IS RESPONSIBLE FOR THEIR OWN HORIZONTAL AND VERTICAL CONTROL, REFERENCE POINTS AND CONSTRUCTION STAKING AS INCIDENTAL TO THE PROJECT.
 - THE CONTRACTOR SHALL FIELD VERIFY EXISTING ELEVATIONS/PROPERTY LINES/UTILITIES/DRAINAGE PRIOR TO CONSTRUCTION START.
 - ALL SITE EXCAVATION SHALL BE CONSIDERED UNCLASSIFIED EXCAVATION.
 - GENERAL CONTRACTOR TO PROVIDE A UNIT PRICE FOR REMOVAL AND REPLACEMENT OF SOILS ON THIS SITE SHOULD REMOVAL BE REQUIRED.
 - ALL WORK NOT CLASSIFIED AS A CONTRACT PAY ITEM SHALL BE CONSIDERED AS INCIDENTAL AND THE COST THEREOF SHALL BE INCLUDED IN THE UNIT PRICE BID FOR ITEMS WHICH ARE CLASSIFIED FOR PAYMENT.
 - CONTRACTOR SHALL PROVIDE FINAL GRADES THAT DO NOT OBSTRUCT ANY UTILITY ACCESS AND PROVIDE A SMOOTH TRANSITION TO MEET AND MATCH EXISTING GRADES ON ALL SIDES.
 - ADA ROUTES ARE NOT TO EXCEED 1:20 RUNNING SLOPE AND 2% CROSS SLOPE. HANDICAP PARKING AND ACCESS AISLES SHALL NOT EXCEED 2% IN ANY DIRECTION.
 - ALL NATURAL GROUND SLOPES SHALL NOT EXCEED 3:1. PAVING SLOPES SHALL NOT EXCEED 8%.
 - CONTRACTOR SHALL ENSURE THAT ALL NECESSARY EARTH DISTURBING PERMITS HAVE BEEN ACQUIRED AND MEET THE CONDITIONS/REQUIREMENTS SET FORTH IN THE PERMITS PRIOR TO CONSTRUCTION.
 - CONTRACTOR IS REQUIRED TO CALL ONE CALL AS WELL AS THE APPROPRIATE UTILITY COMPANY AT LEAST 48 HOURS BEFORE ANY EXCAVATION/CONSTRUCTION ACTIVITIES TAKE PLACE. IT SHALL BE THE RESPONSIBILITY OF THE CONTRACTOR TO RELOCATE ALL EXISTING UTILITIES WHICH ARE IN CONFLICT WITH PROPOSED IMPROVEMENTS.
 - THE CONTRACTOR SHALL GRADE SITE TO ENSURE ALL SURFACE WATER DRAINAGE IS AWAY FROM THE BUILDING AND PROVIDES POSITIVE DRAINAGE SO THAT NO STANDING/PONDING WATER TAKES PLACE ON SITE OR ON ADJACENT PROPERTIES.
 - ALL CONSTRUCTION SHALL BE IN STRICT ACCORDANCE WITH THE OWNERS DESIGN GUIDELINES AND SPECIFICATIONS, AND WHERE APPLICABLE SHALL MEET THE REQUIREMENTS OF THE GOVERNING/PERMITTING AUTHORITY HAVING JURISDICTION.
 - THE BUILDING SUBGRADE SHALL BE CONSTRUCTED TO INCLUDE A MINIMUM OF 10 FEET BEYOND THE BUILDING LIMITS AS SHOWN ON THE PLANS, OR AS DIRECTED BY THE OWNER.
 - REFERENCE ARCHITECTURAL AND STRUCTURAL DRAWINGS FOR REQUIRED FLOOR SLAB THICKNESS.
 - THE BUILDING PAD SUBGRADE SHALL BE PREPARED IN STRICT ACCORDANCE WITH THE GEOTECHNICAL ENGINEERING STUDY AND THE CIVIL SPECIFICATIONS.
 - ESTABLISH FINAL SUBGRADE ELEVATIONS TO ALLOW FOR PAVEMENT/SLAB SECTIONS AS INDICATED ON THE PLANS.
 - IF CONFLICTS EXIST BETWEEN THE GEOTECHNICAL REPORT AND THE CONSTRUCTION DRAWINGS AND SPECIFICATIONS, THE MORE STRINGENT REQUIREMENTS SHALL APPLY.

SPOT ELEVATION LEGEND

TC - TOP OF CURB	FF - FINISH FLOOR
G - GUTTER	FG - FINAL GRADE
TP - TOP OF PAVEMENT	TW - TOP OF WALL
HP - HIGH POINT	BW - BOTTOM OF WALL
LP - LOW POINT	NOTE: BW IS BOTTOM OF WALL AT GRADE, NOT FOOTING
SW - SIDEWALK	


VERTICAL SEPARATION REQUIREMENT

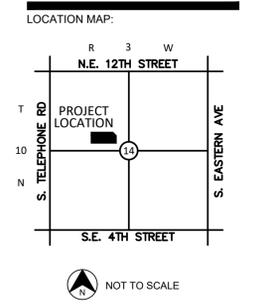

CENTRAL JUNIOR HIGH CLASSROOM ADDITION

400 N. BROADWAY ST.
MOORE, OKLAHOMA

PROJECT NUMBER: 25031
DRAWING DATE: 06.02.25
ISSUE DATE: 06.02.25

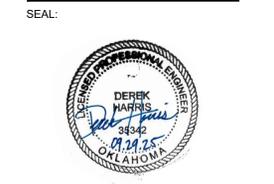


SUBMITTAL:
PERMIT SET

REVISIONS:

08.13.25	ADDENDUM 03
09.29.25	CB-4


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DRAWING TITLE:

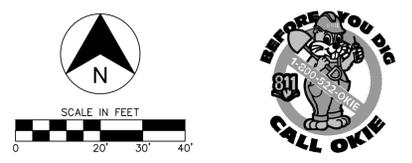

GRADING PLAN EAST


SHEET:
C4.01

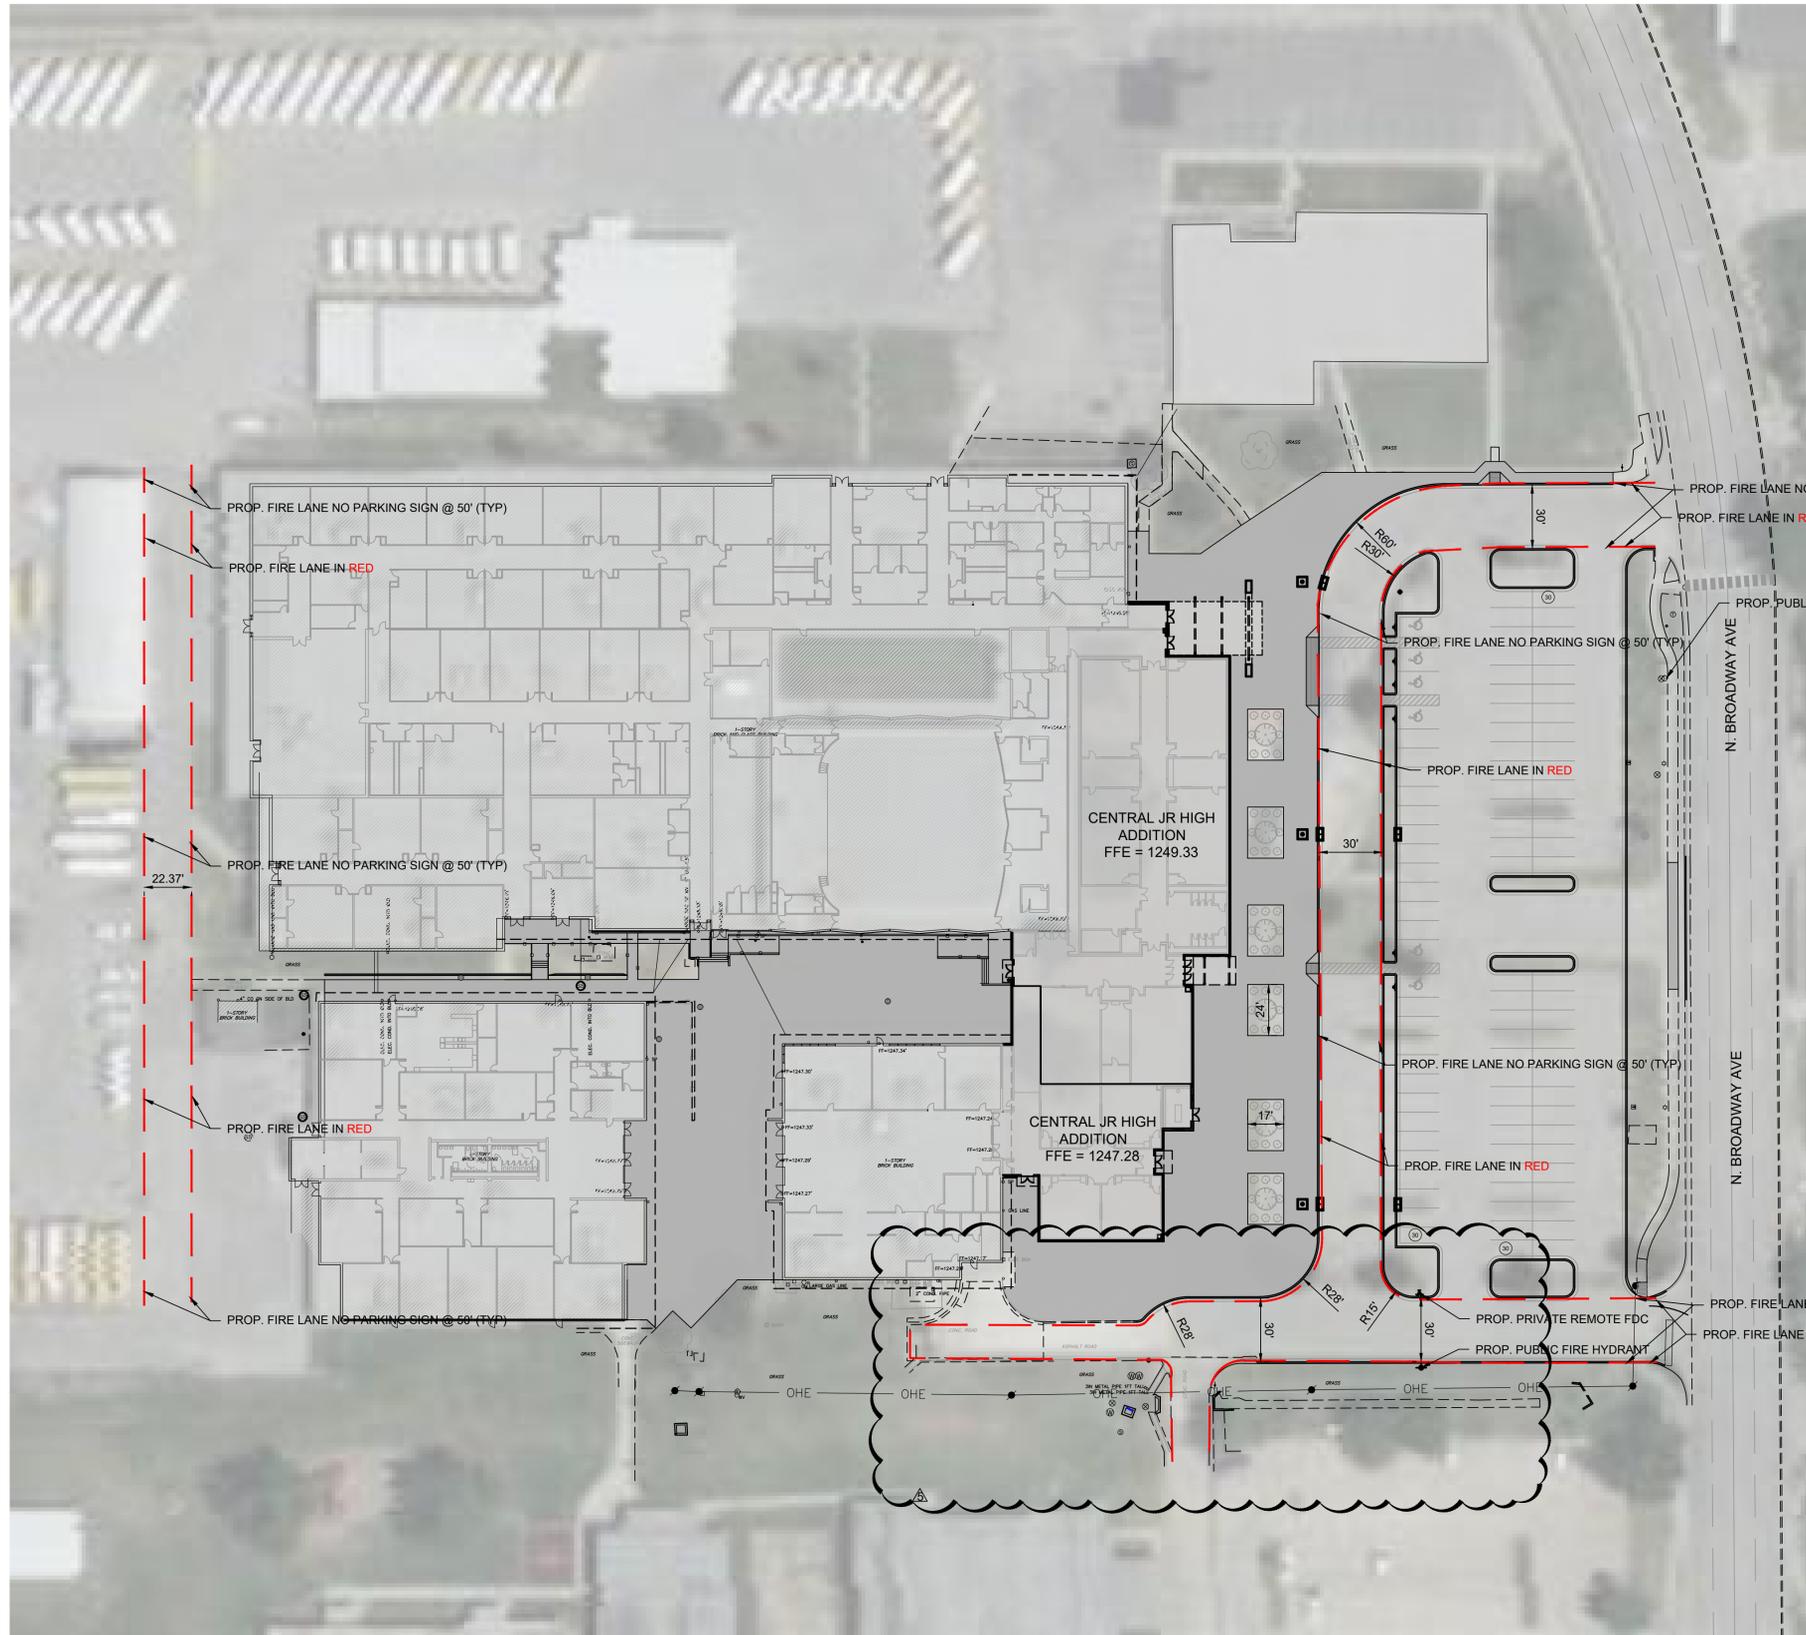

LEGEND

	EXISTING 1' CONTOUR		EXISTING 5' CONTOUR
	PROPOSED 1' CONTOUR		PROPOSED 5' CONTOUR
	BOUNDARY LINE		RIGHT OF WAY LINE
	EASEMENT LINE		EXISTING CURB AND GUTTER
	PROPOSED CURB AND GUTTER		PROPOSED FIRE LANE STRIPING
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	UGT		UNDERGROUND TELEPHONE LINE
	FO		UNDERGROUND FIBER OPTIC LINE
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	W		WATERLINE
	RETAINING WALL		SCREEN WALL
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	PROP. BOLLARD		PROP. GAS METER
	PROP. TRANSFORMER		PROP. SIGN
	PROP. PARKING COUNT		PROP. FIRE ROUTE SIGN
	PROP. INLETS (SEE GRADING PLAN FOR TYPE)		
	VERTICAL SEPARATION REQUIREMENT		

***NOTE: REFER TO SURVEYING LEGEND FOR EXISTING STRUCTURES IDENTIFICATION**

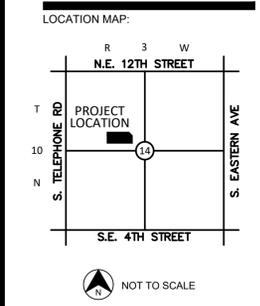

PROJECT:

CENTRAL JUNIOR HIGH CLASSROOM ADDITION

400 N. BROADWAY ST. MOORE, OKLAHOMA

PROJECT NUMBER: 25031
DRAWING DATE: 06.02.25
ISSUE DATE: 06.02.25

SEAL:

SUBMITTAL:

PERMIT SET

REVISIONS:

	08.13.25	ADDENDUM 03
	09.29.25	CB-4

MARK	DATE	DESCRIPTION
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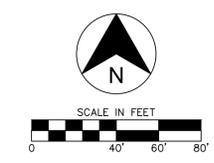
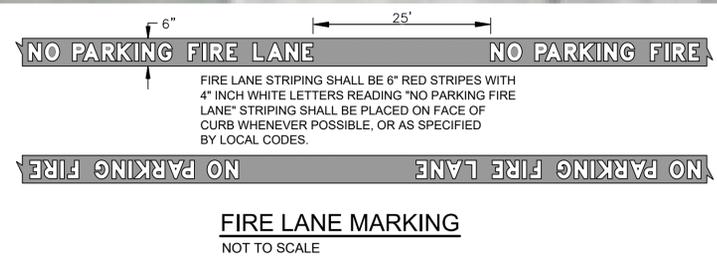
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DRAWING TITLE:

FIRE PLAN

SHEET:

F1.00





CJC

drawn by

BWB

checked by

FEBRUARY 2025

date

revisions

- 1 ADD #1 07/16/2025
- 2 ADD #4 08/15/2025
- 3 CB-4 09/30/2025

MOORE PUBLIC SCHOOLS
BOARD OF EDUCATION
MOORE, OKLAHOMA




CLASSROOM ADDITION
CENTRAL JUNIOR
HIGH SCHOOL

sheet no:


S202

OWNERSHIP USE OF DOCUMENTS:


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CONSENT OF AGP.

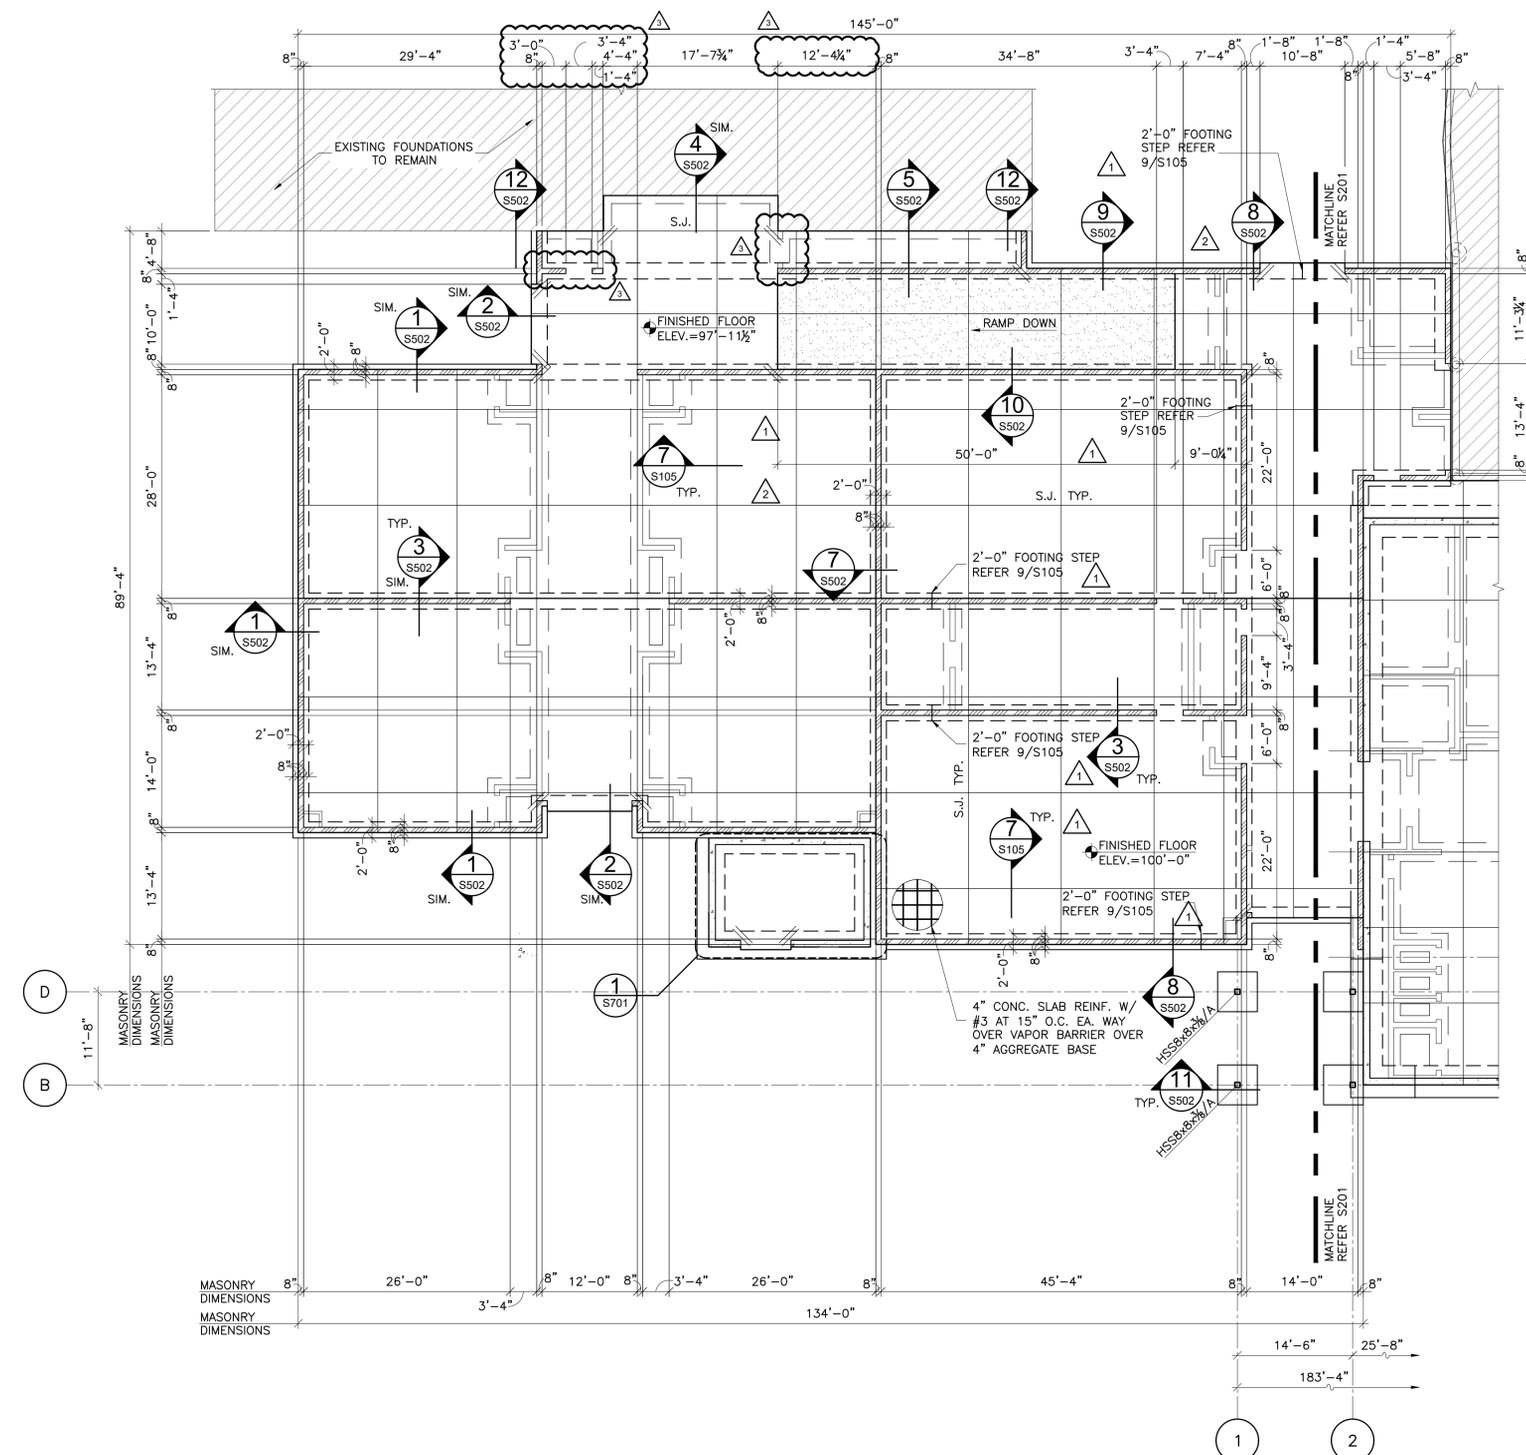

NOTE:
REFER S201 FOR
FOUNDATION PLAN
NOTES AND LEGEND

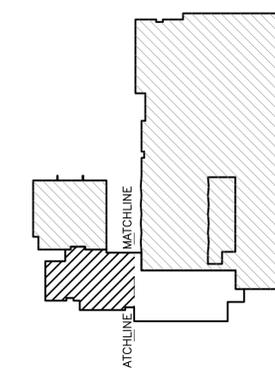

FOUNDATION PLAN - AREA "B"
SCALE: 3/32"=1'-0"

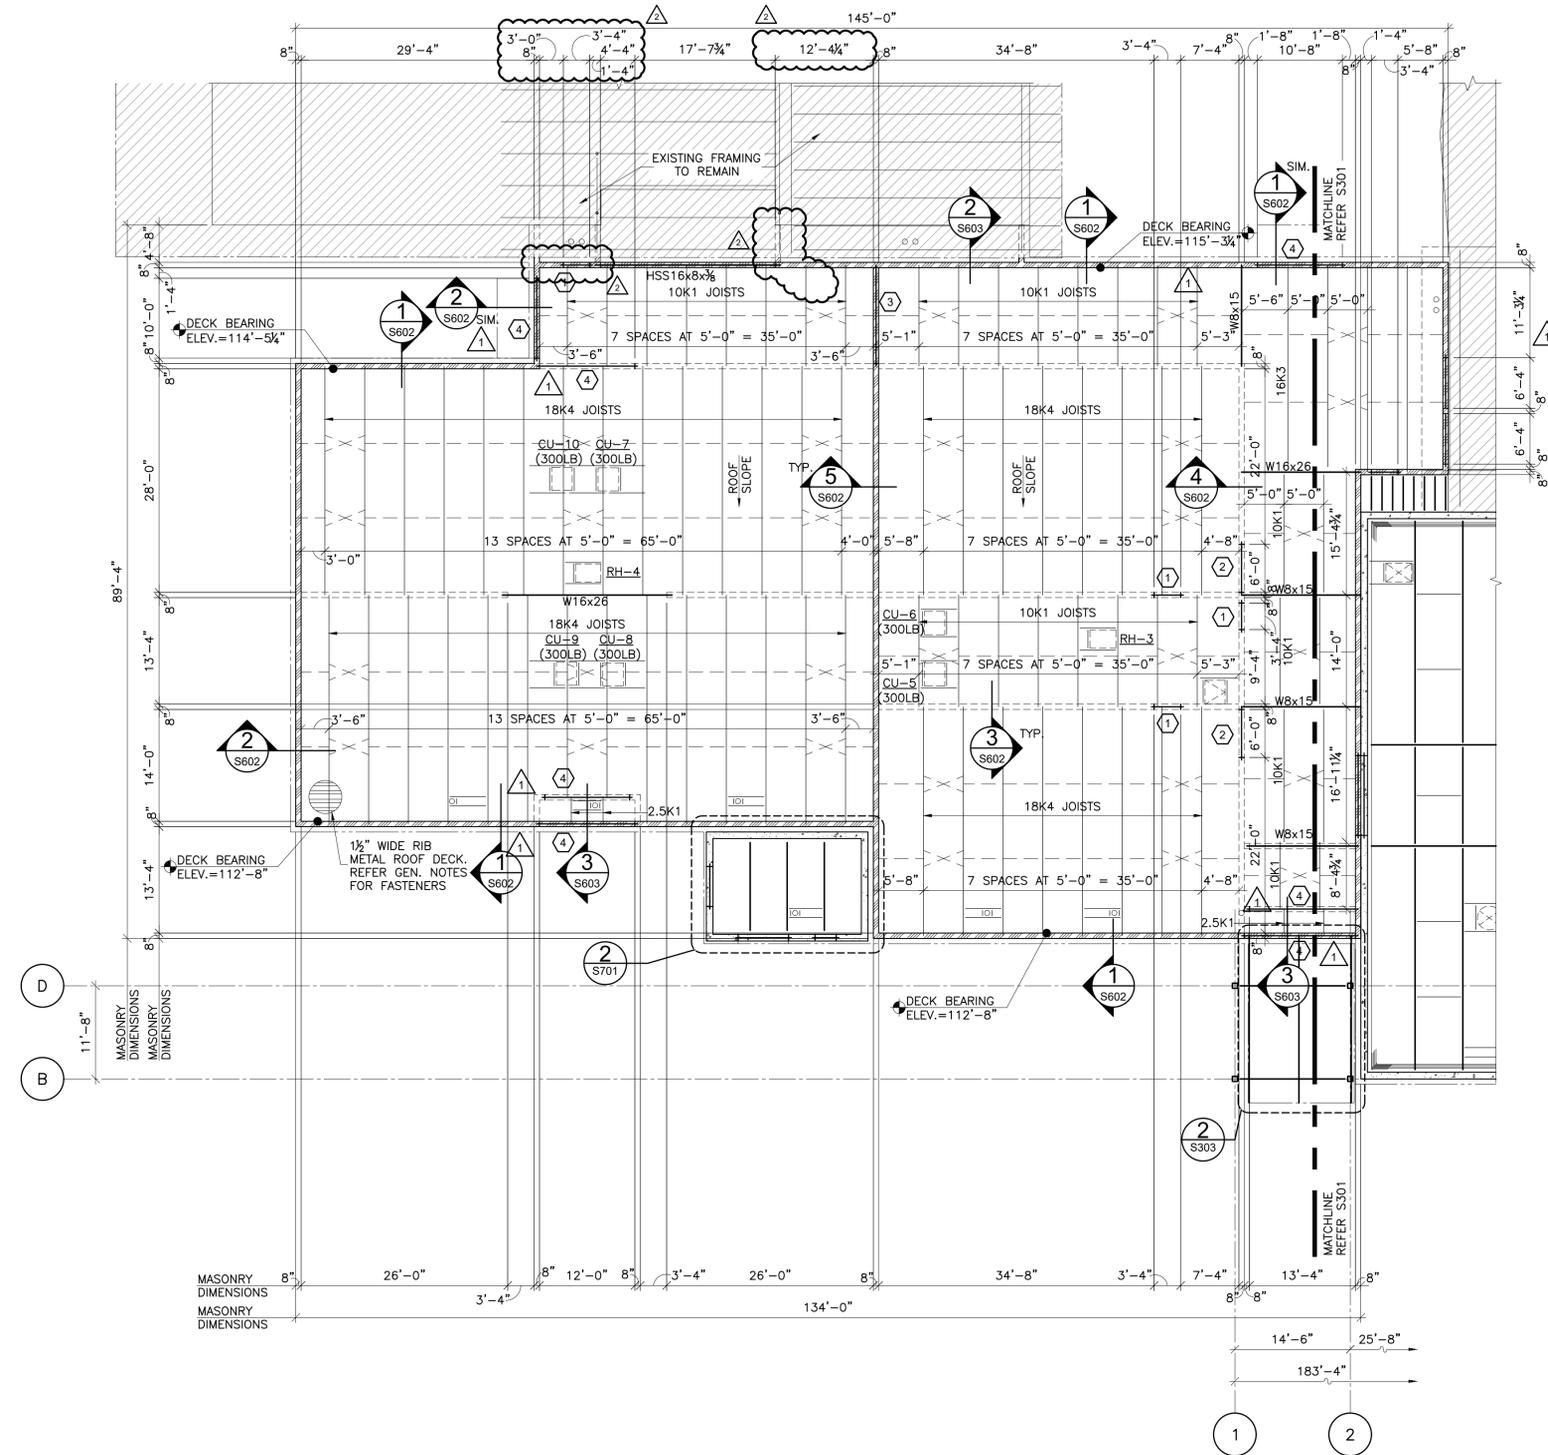

1 FRAMING PLAN - AREA "B"
SCALE: 3/32"=1'-0"

CJC	drawn by
BWB	checked by
FEBRUARY 2025	date
revisions	
1	ADD #4 08/15/2025
2	CB-4 09/30/2025

MOORE PUBLIC SCHOOLS
BOARD OF EDUCATION
MOORE, OKLAHOMA





CLASSROOM ADDITION
CENTRAL JUNIOR
HIGH SCHOOL

sheet no:

S302


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1 WEST ELEVATION
1/8" = 1'-0"

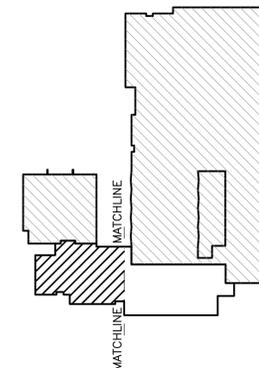- GENERAL NOTES:**
- REFER STRUCTURAL DRAWINGS FOR TOP OF FOOTING ELEVATIONS - PROVIDE ALL MATERIALS REQUIRED FOR WALL SYSTEM TO EXTEND TO TOP OF FOOTING
 - DO NOT SCALE DRAWINGS TO OBTAIN MATERIAL QUANTITIES. USE DRAWINGS WHICH ARE DIMENSIONED OR COORDINATE W/ EXISTING CONDITIONS &/OR ARCHITECT & ENGINEERS.

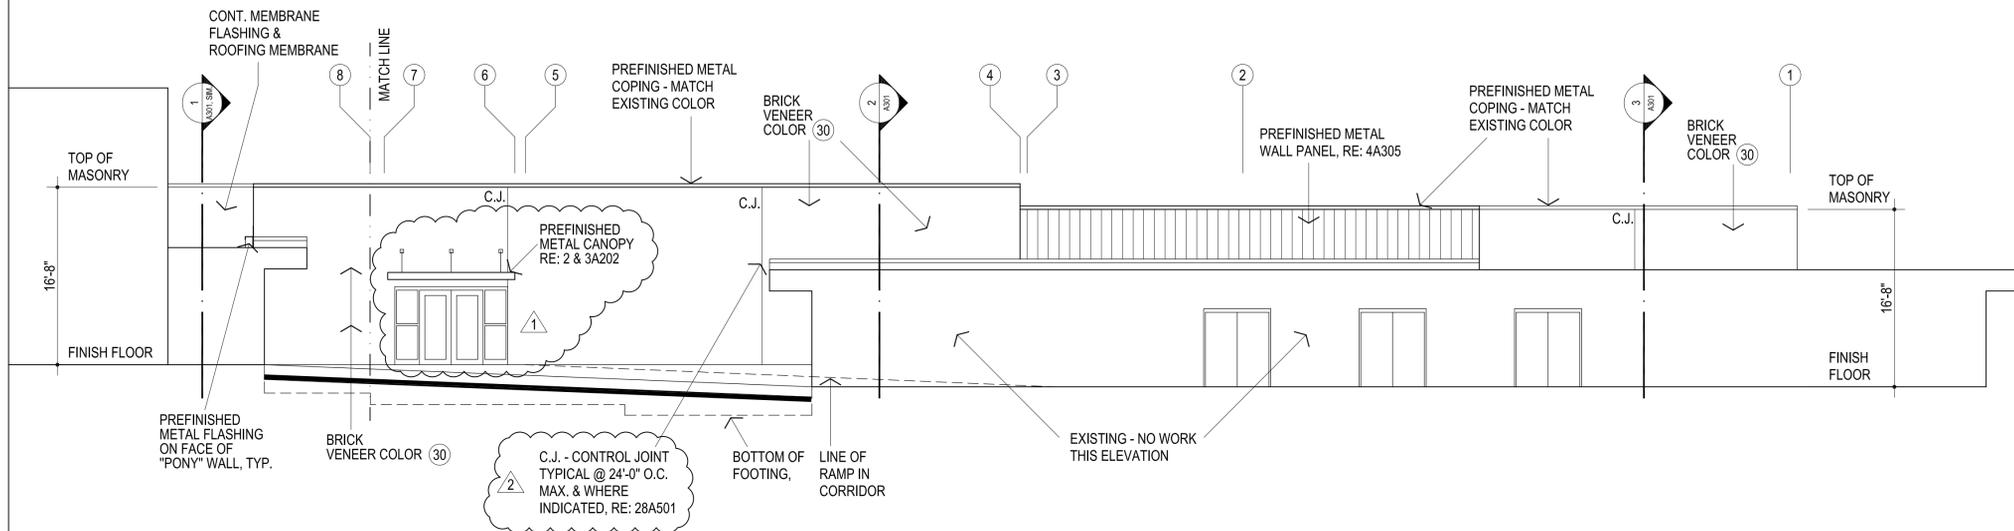

CG
drawn by

MA
checked by

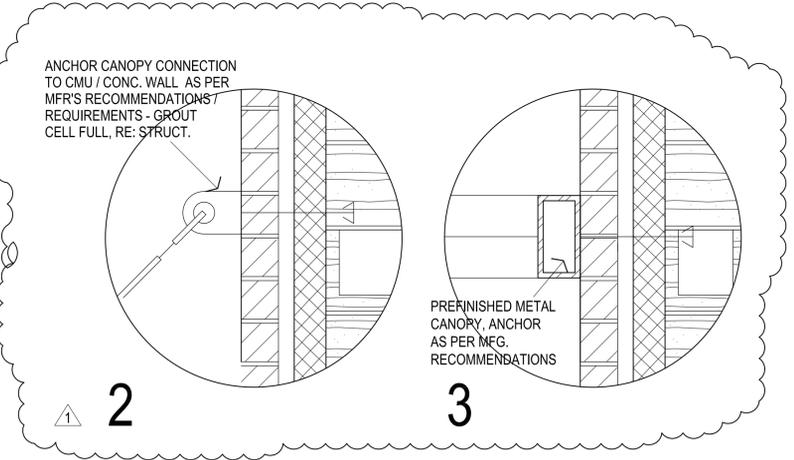APRIL 2025
date

- revisions
- 1 ADDENDUM #1
 - 2 CB-4



MOORE PUBLIC SCHOOLS
BOARD OF EDUCATION
MOORE, OKLAHOMA

CLASSROOM ADDITION
CENTRAL JUNIOR
HIGH SCHOOL

sheet no:

A202
OVERALL FLOOR PLAN

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